

ENERGY EFFICIENT AND AFFORDABLE HOME

900 S. F. BASE PHASE I EXPANSION: MASTER BEDROOM SUITE

ALTERNATE THIRD FLOOR PLAN
ALTERNATE THIRD FLOOR: 3RD & 4TH BEDROOMS & 2ND BATH

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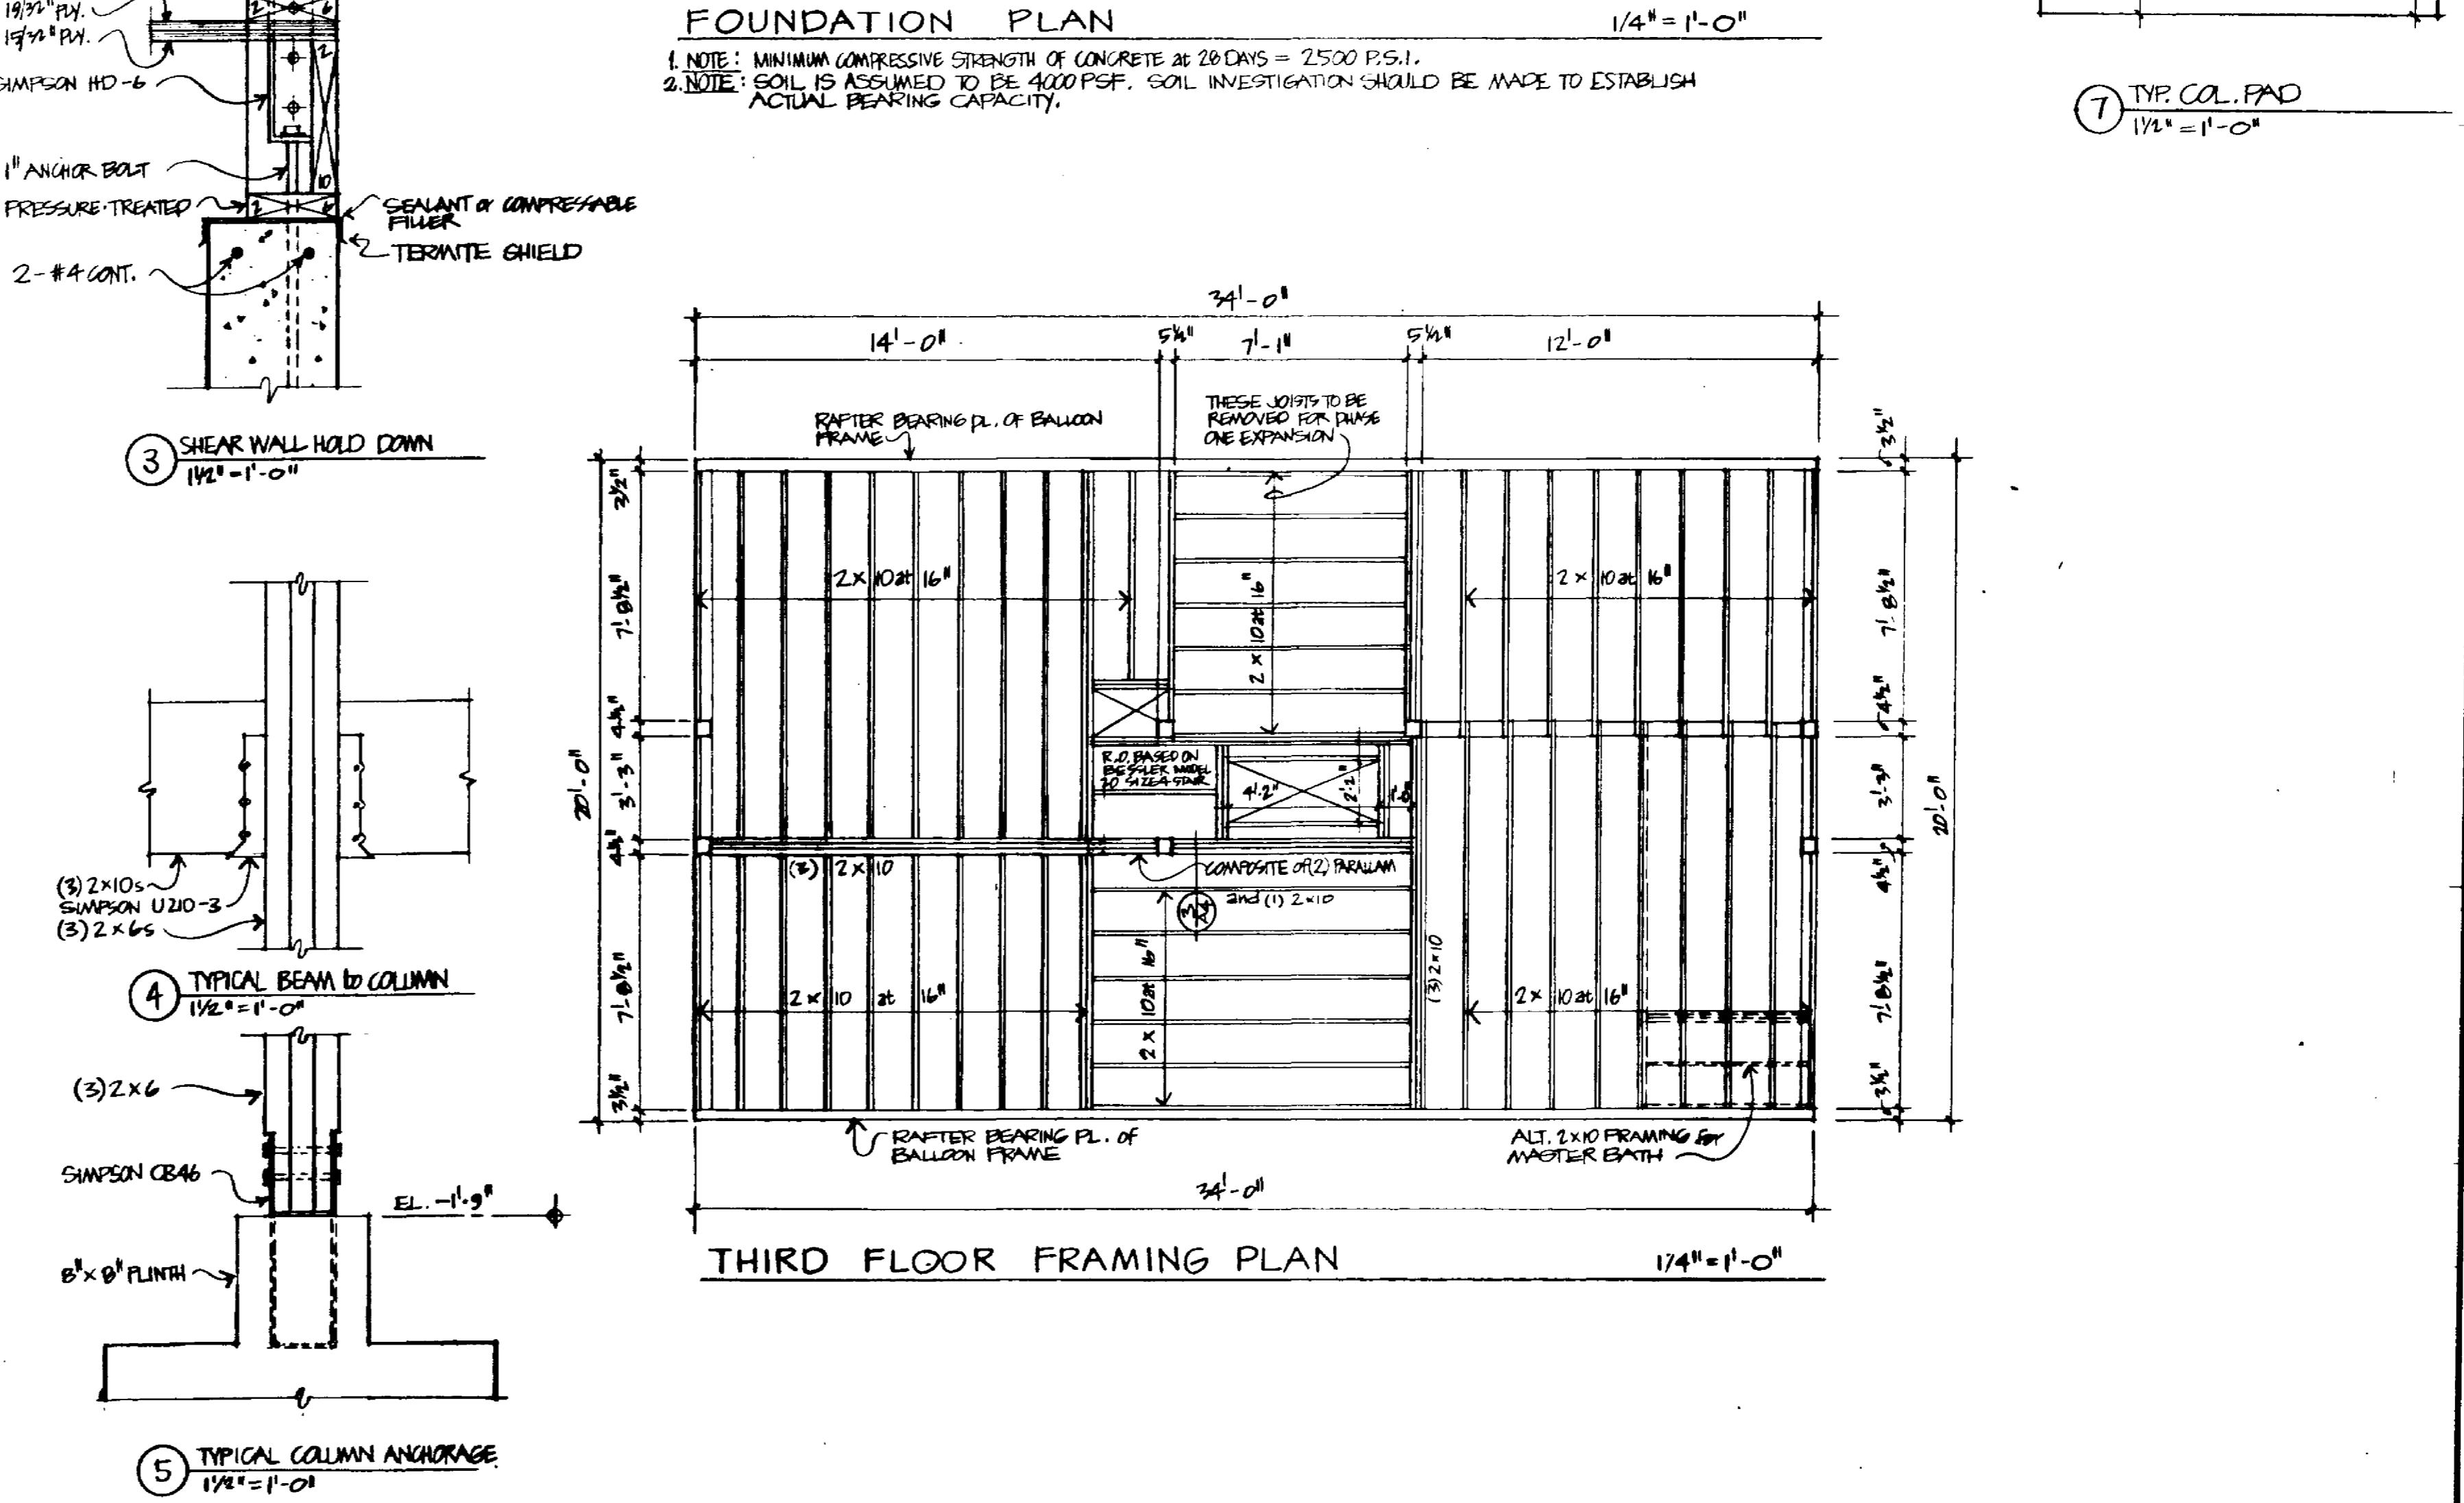
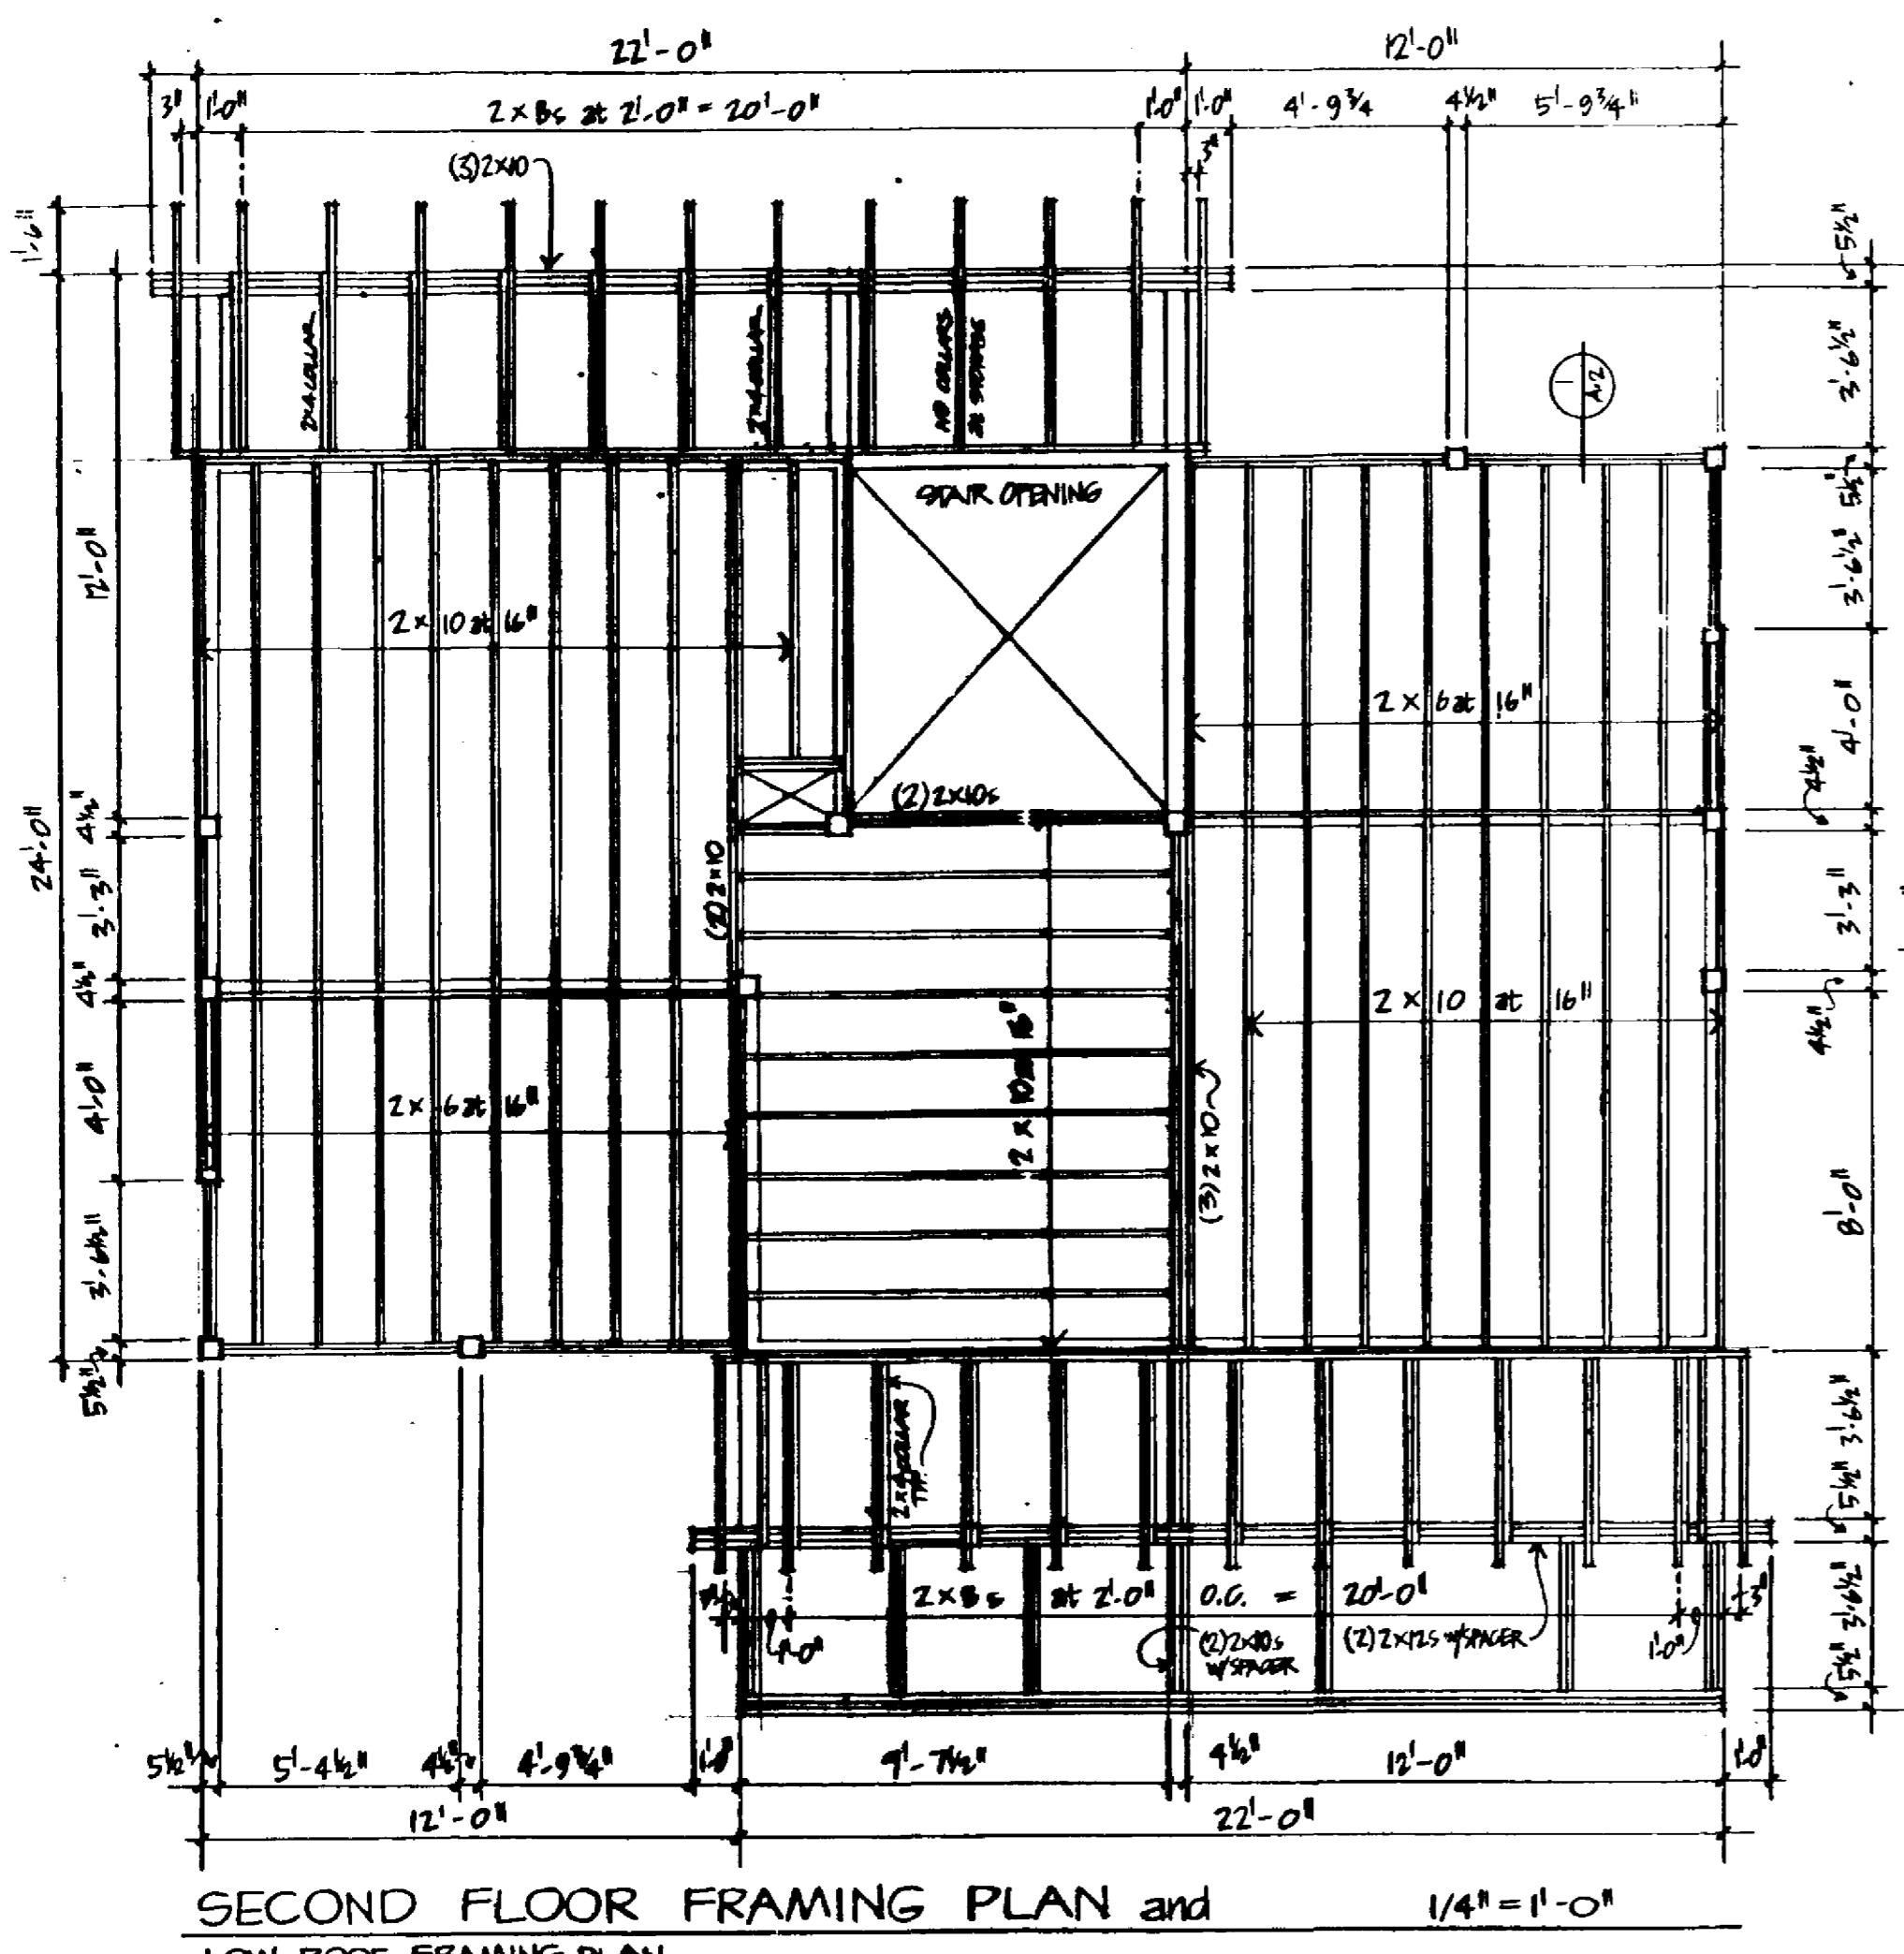
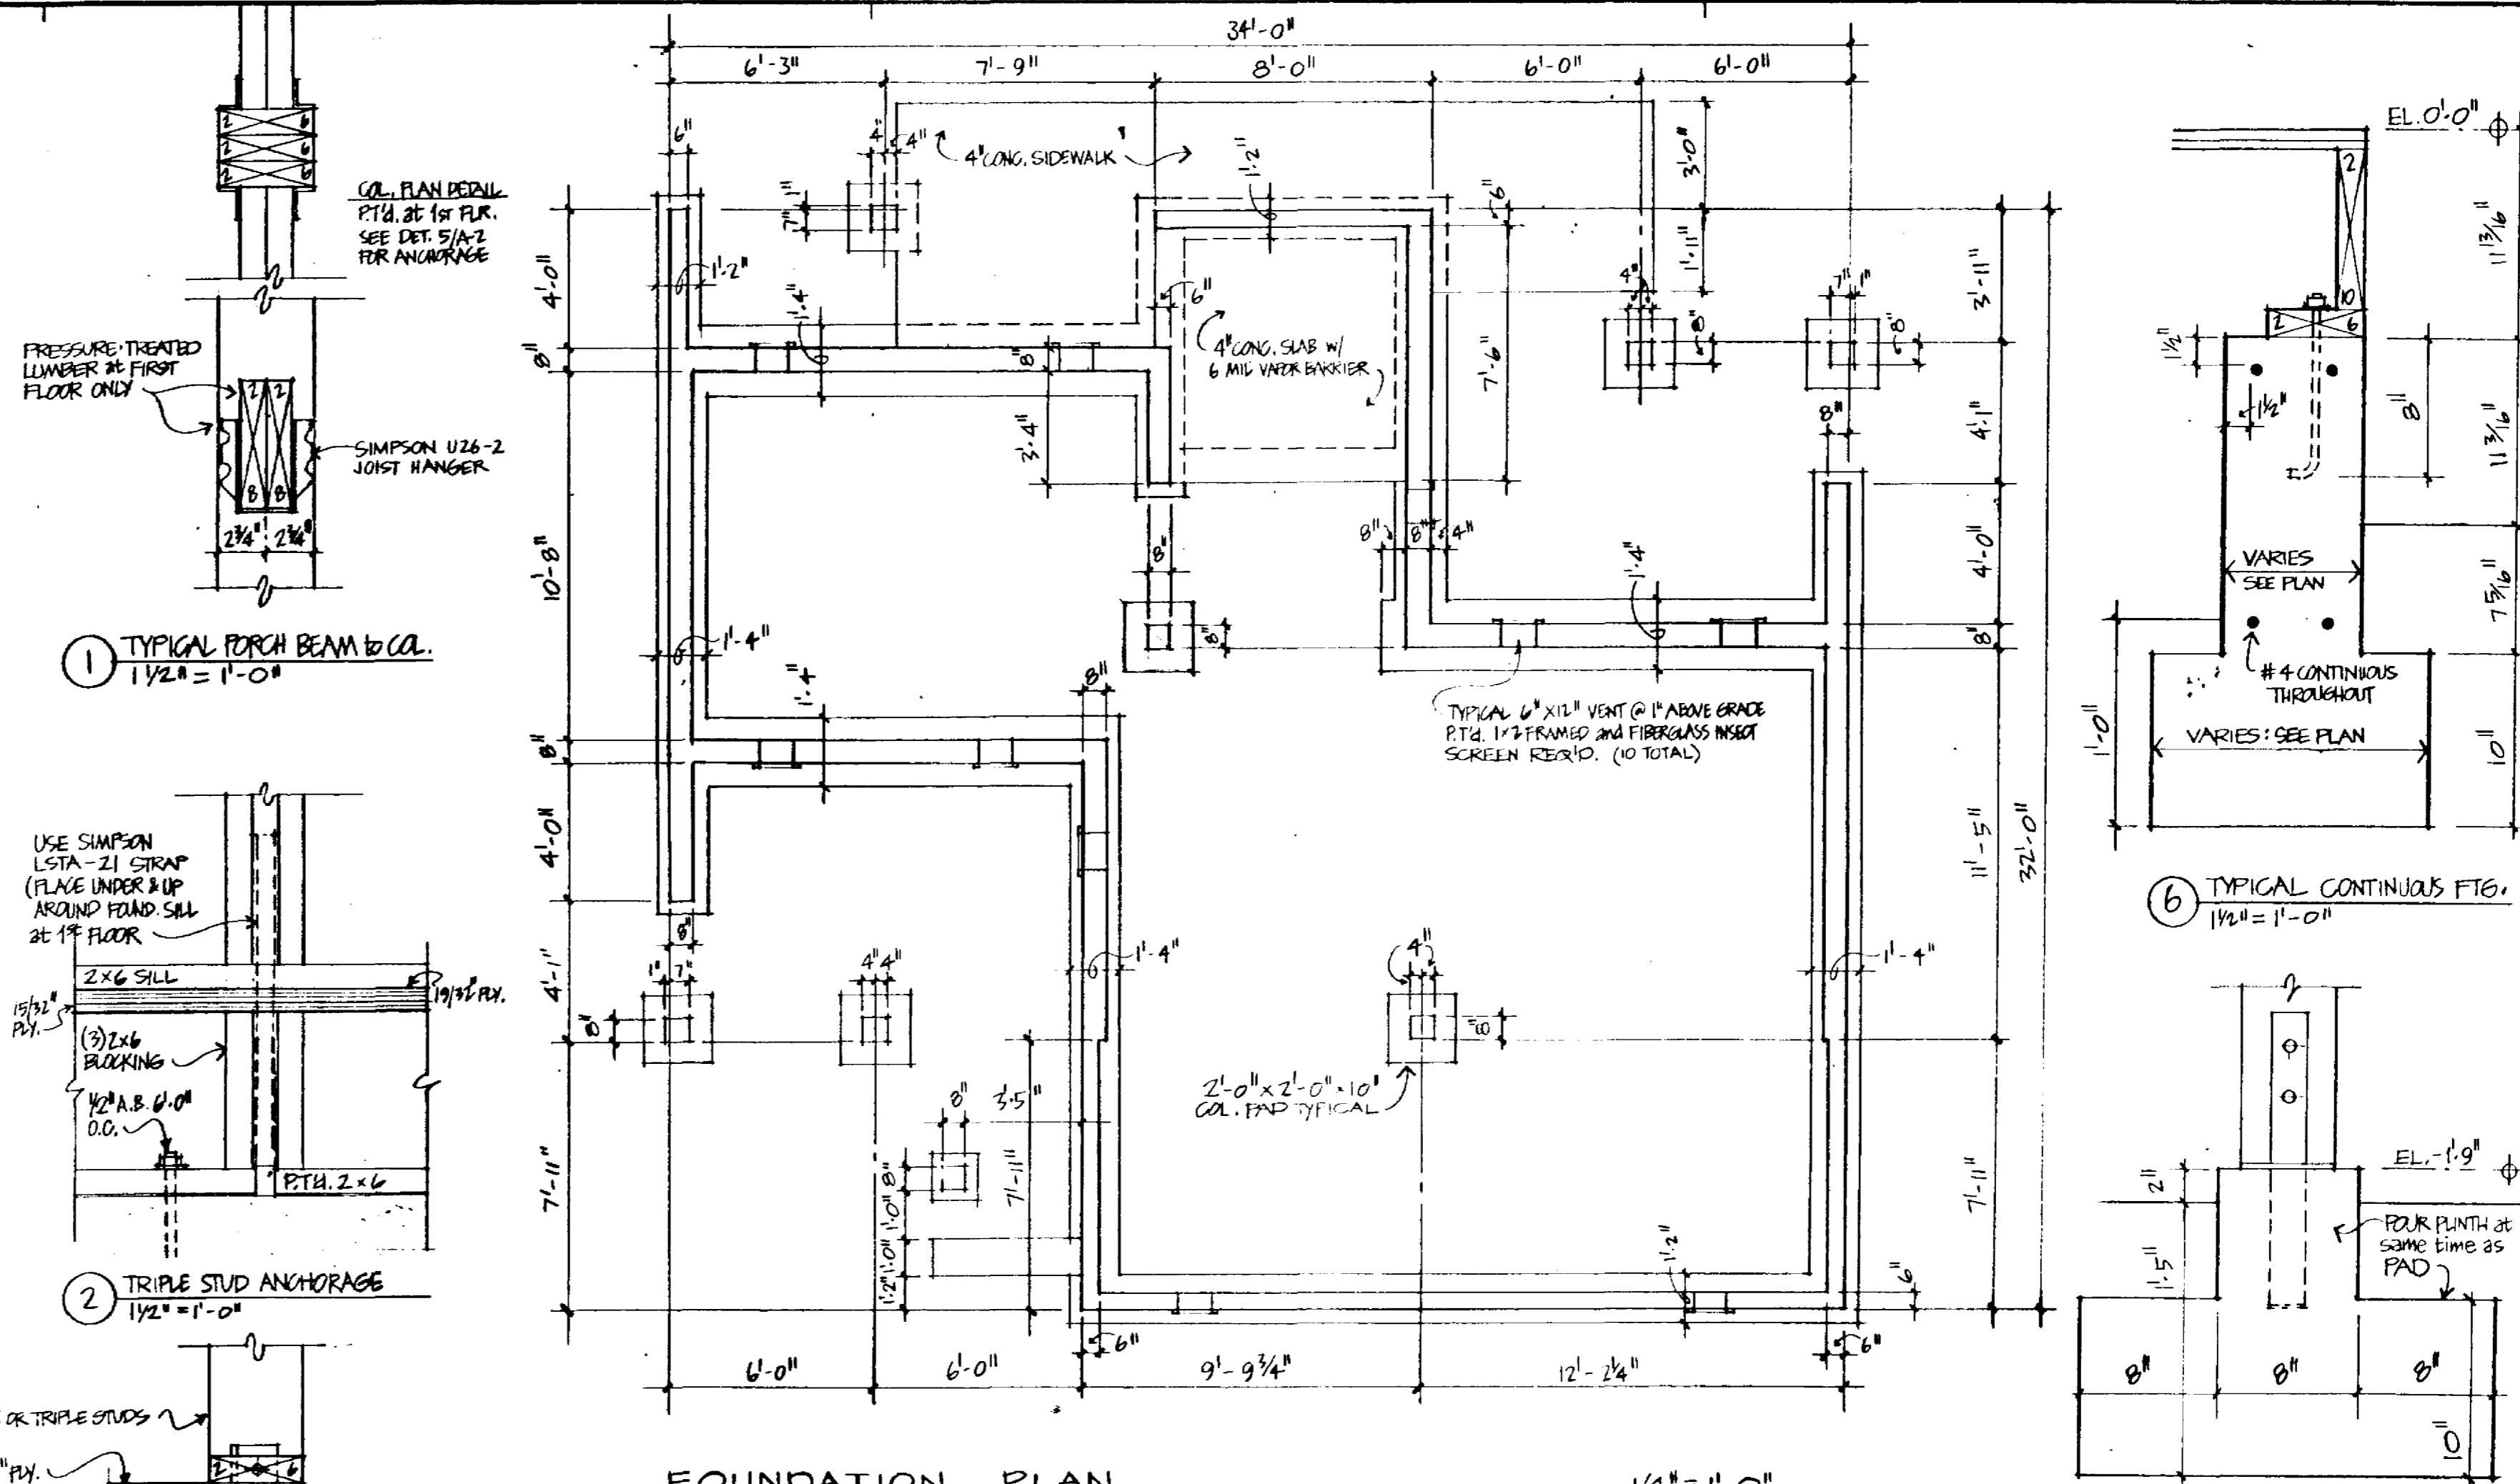
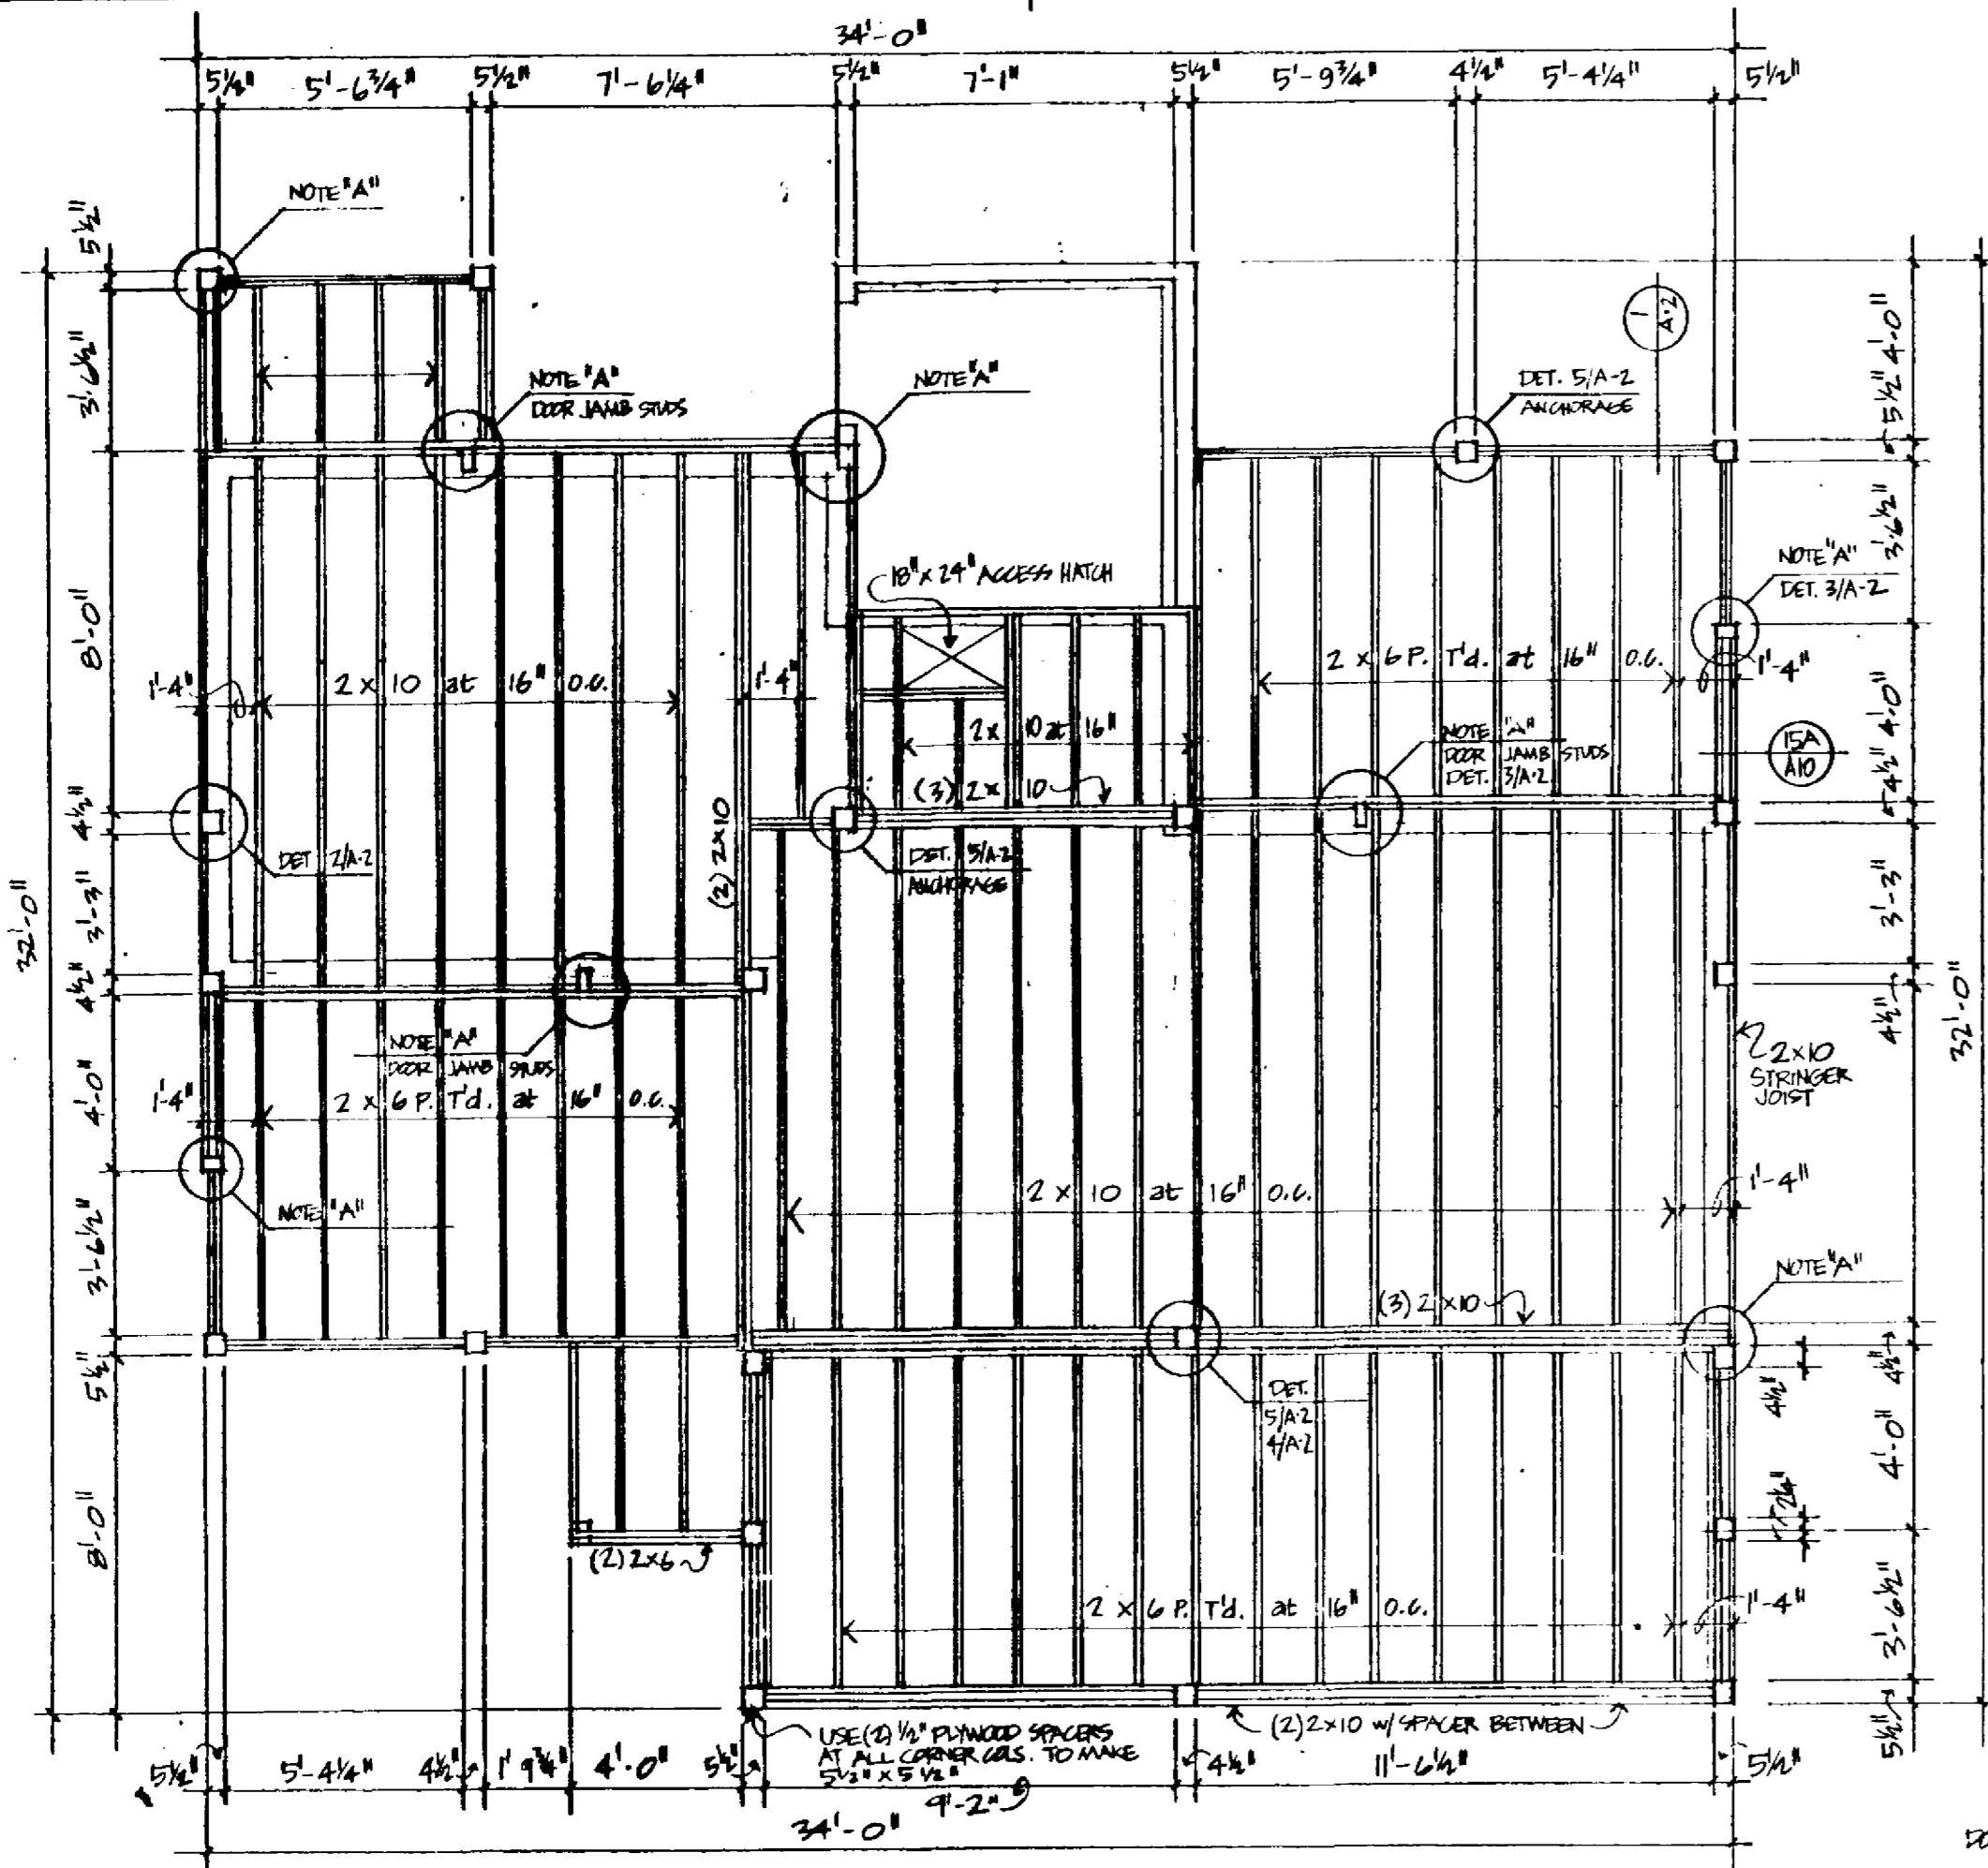
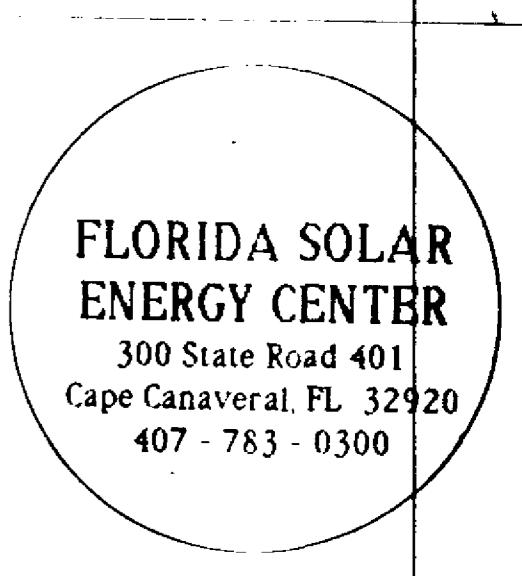
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Project No: 9122
Drawn By: B. EDGERLY
Checked By:
Issue Date: 10-17-91

Rewards
No Date Description By

Drawing Title:

FOUNDATION & FRAMING PLANS

Drawing Number:

A-2

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900 S.F. BASE

PHASE I EXPANSION: MASTER BEDROOM SUITE

ALTERNATE LAUNDRY PLAN

ALTERNATE THIRD FLOOR: 3RD & 4TH

BEDROOMS & 2ND BATH

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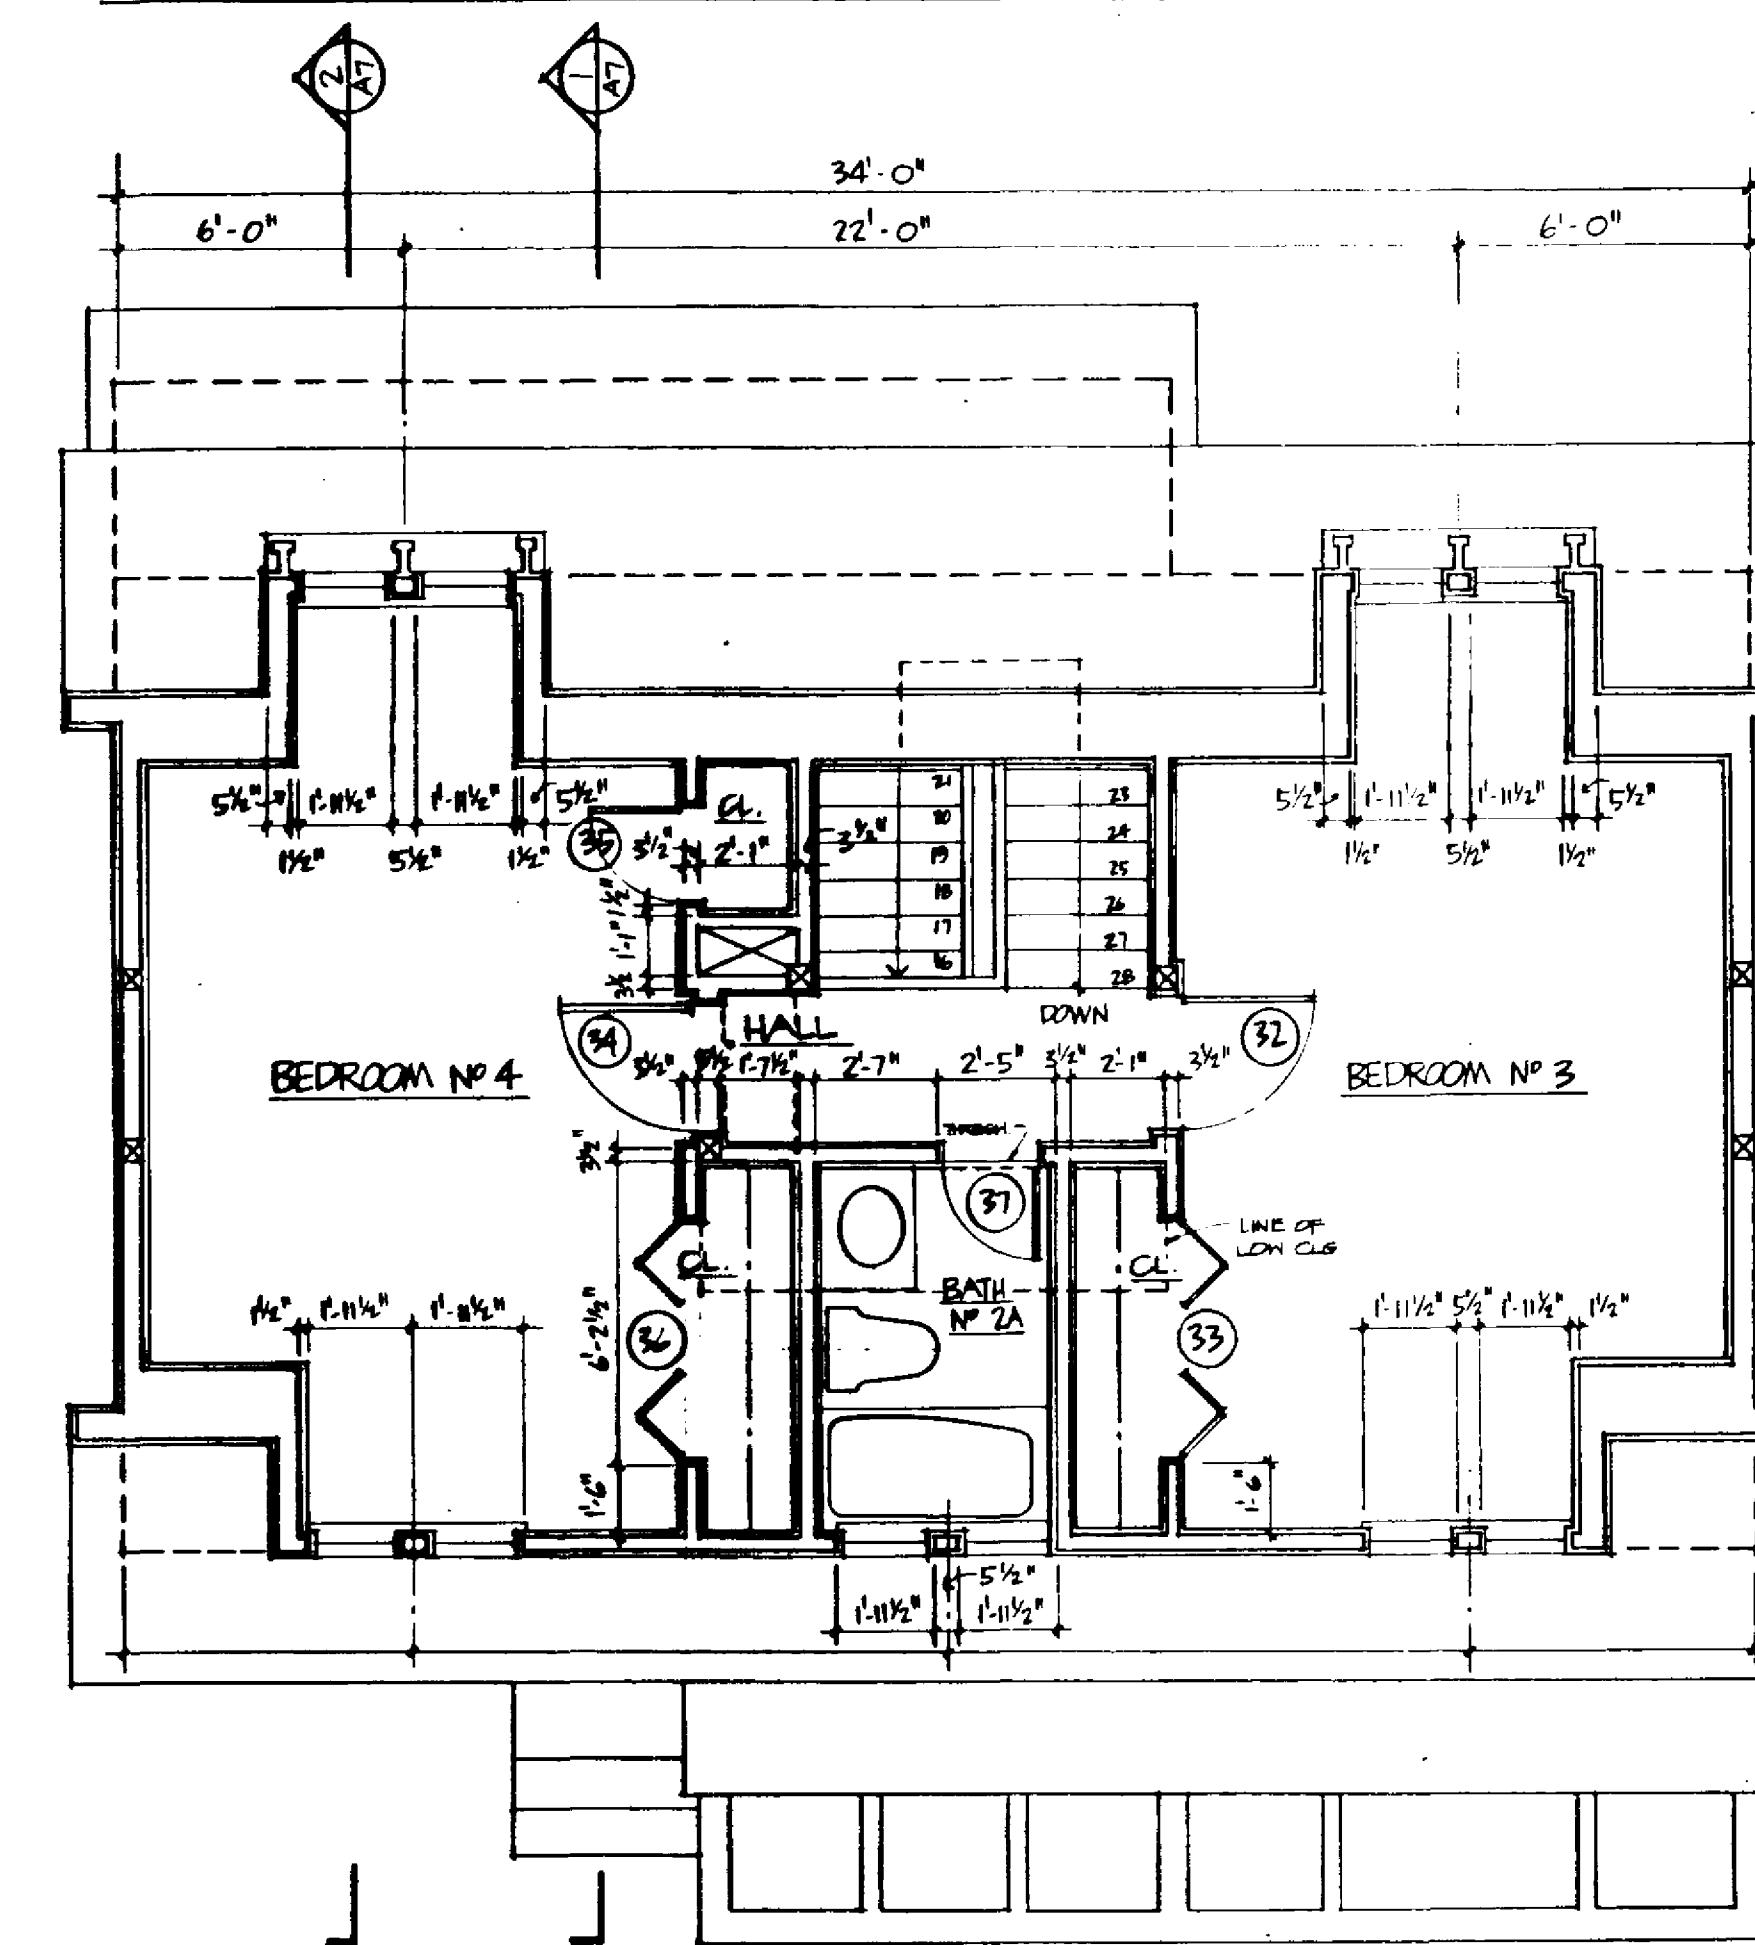
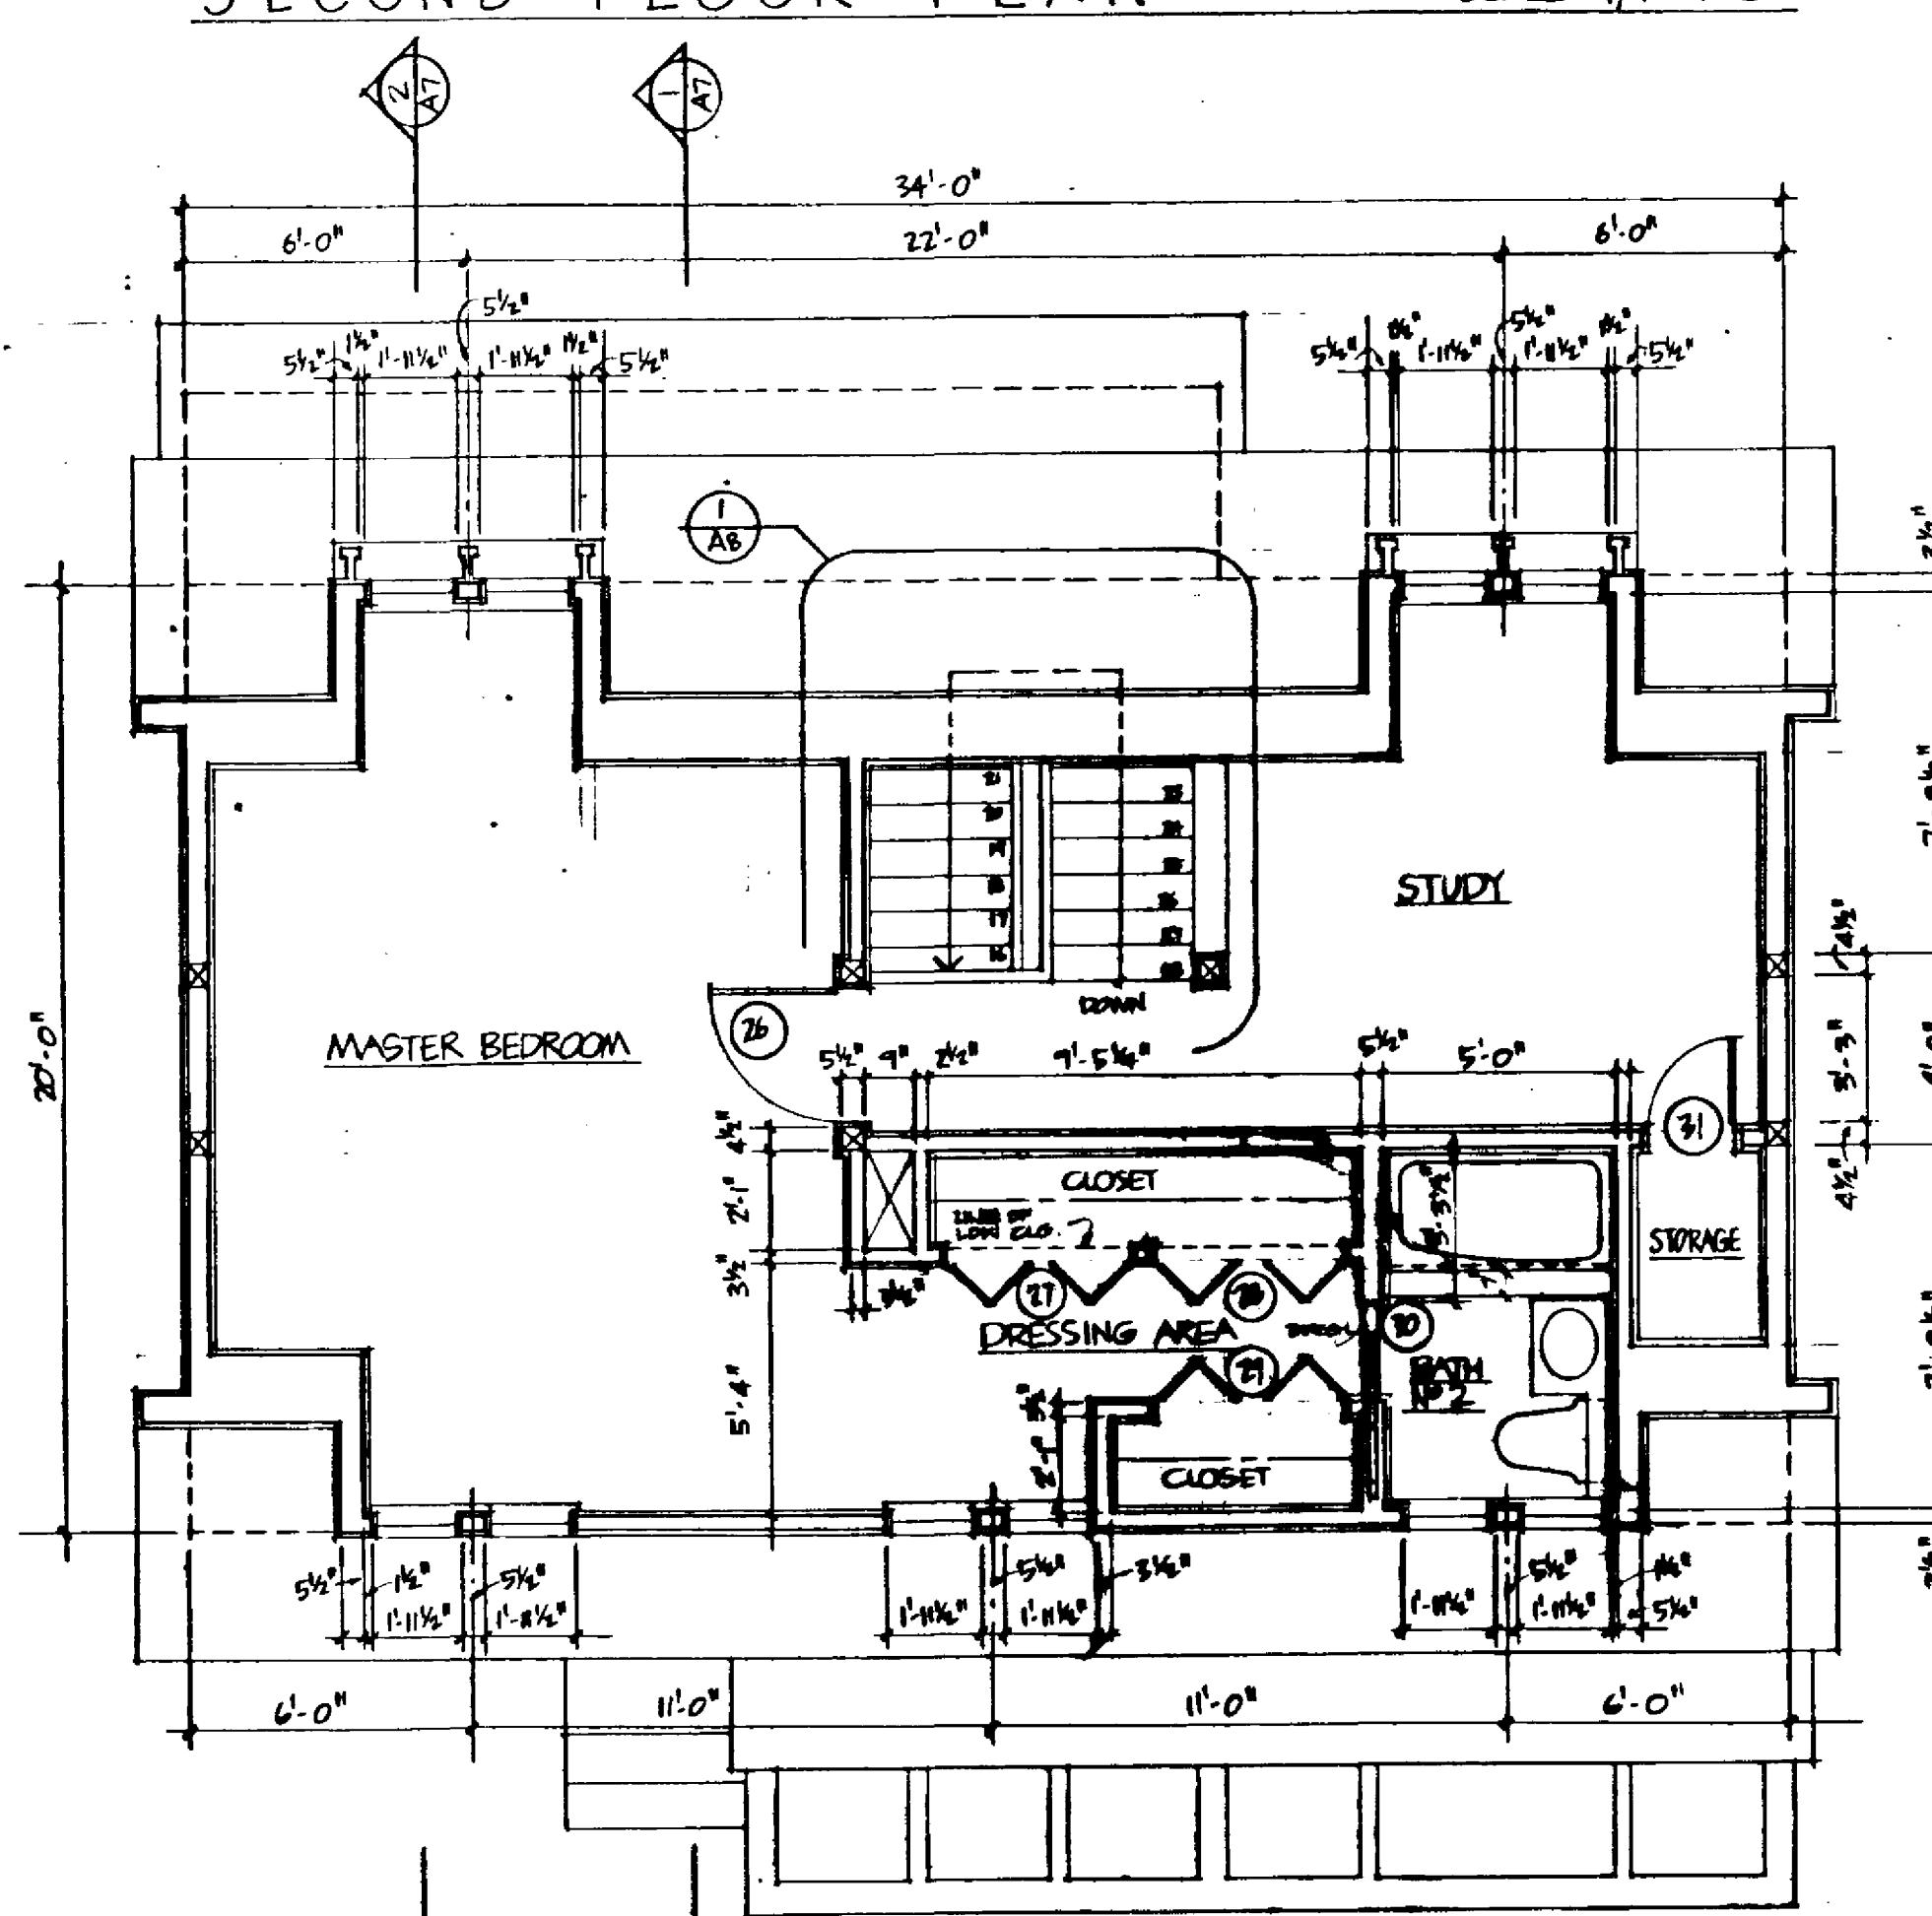
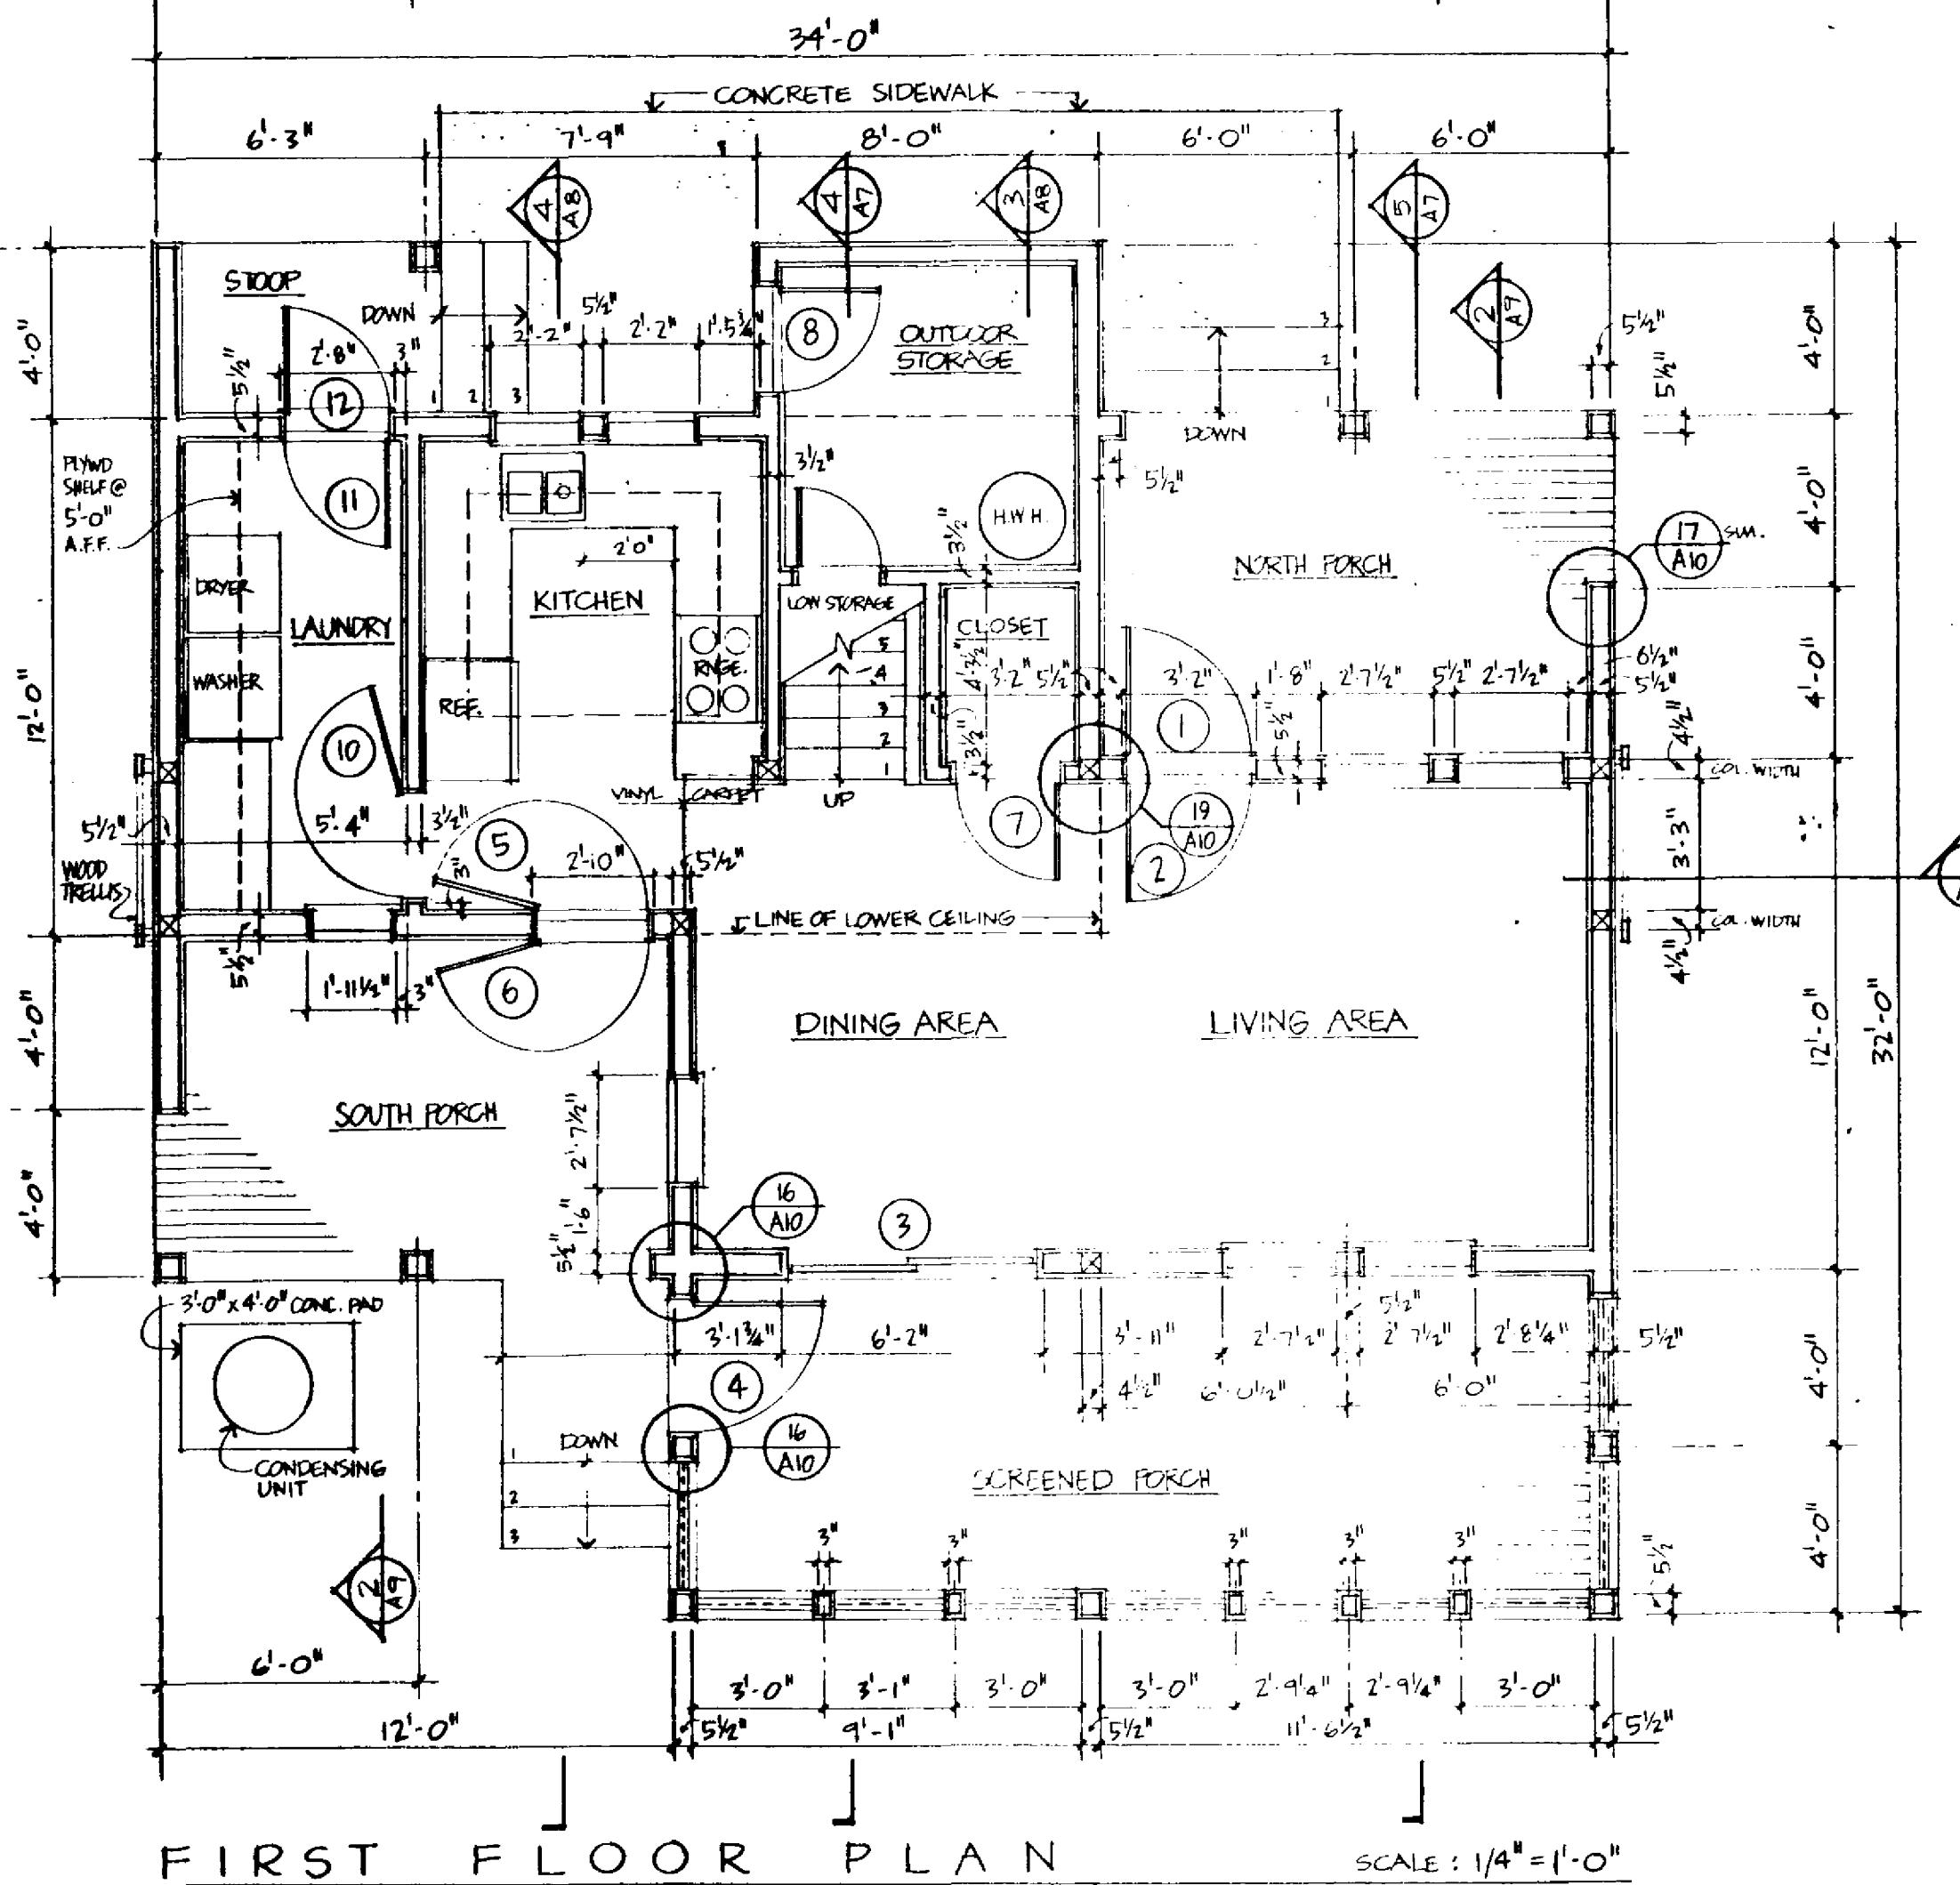
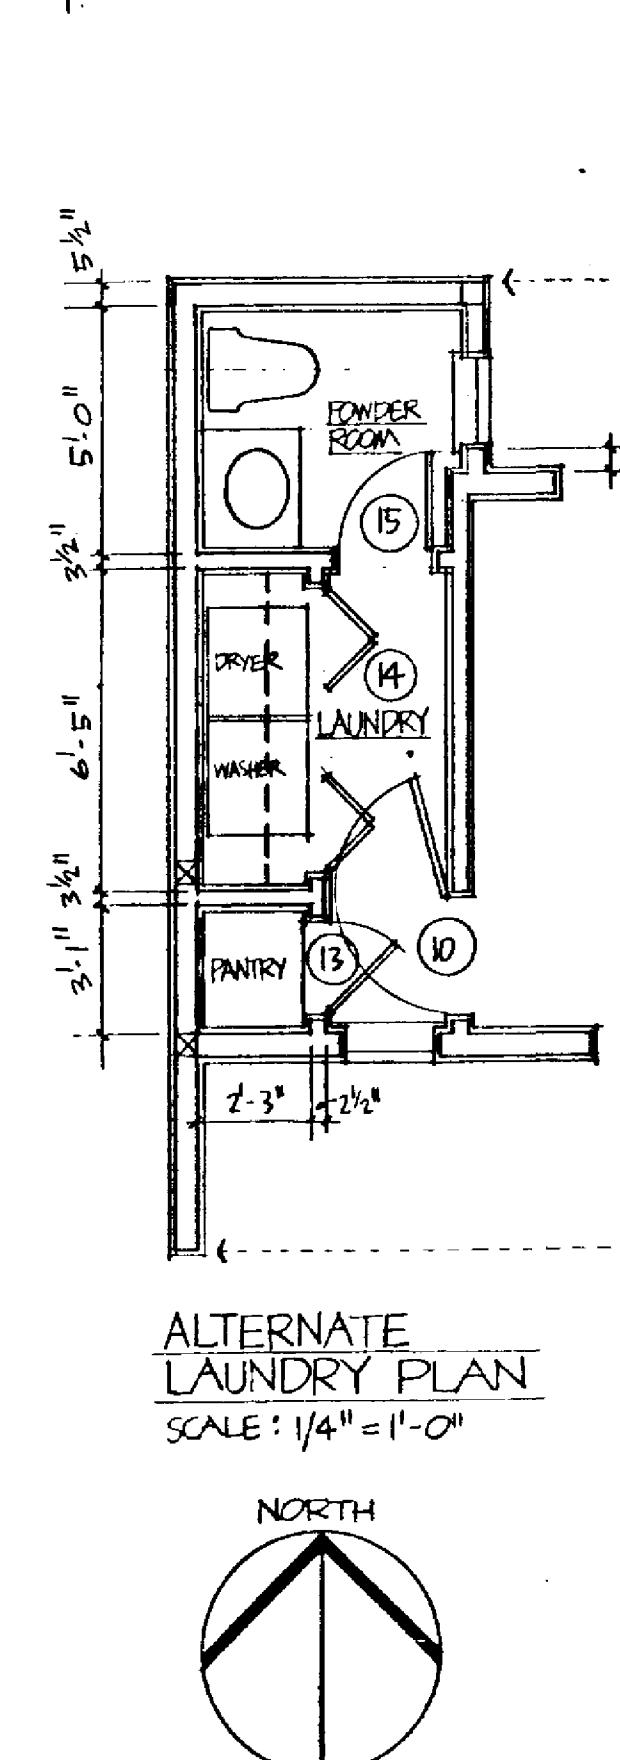
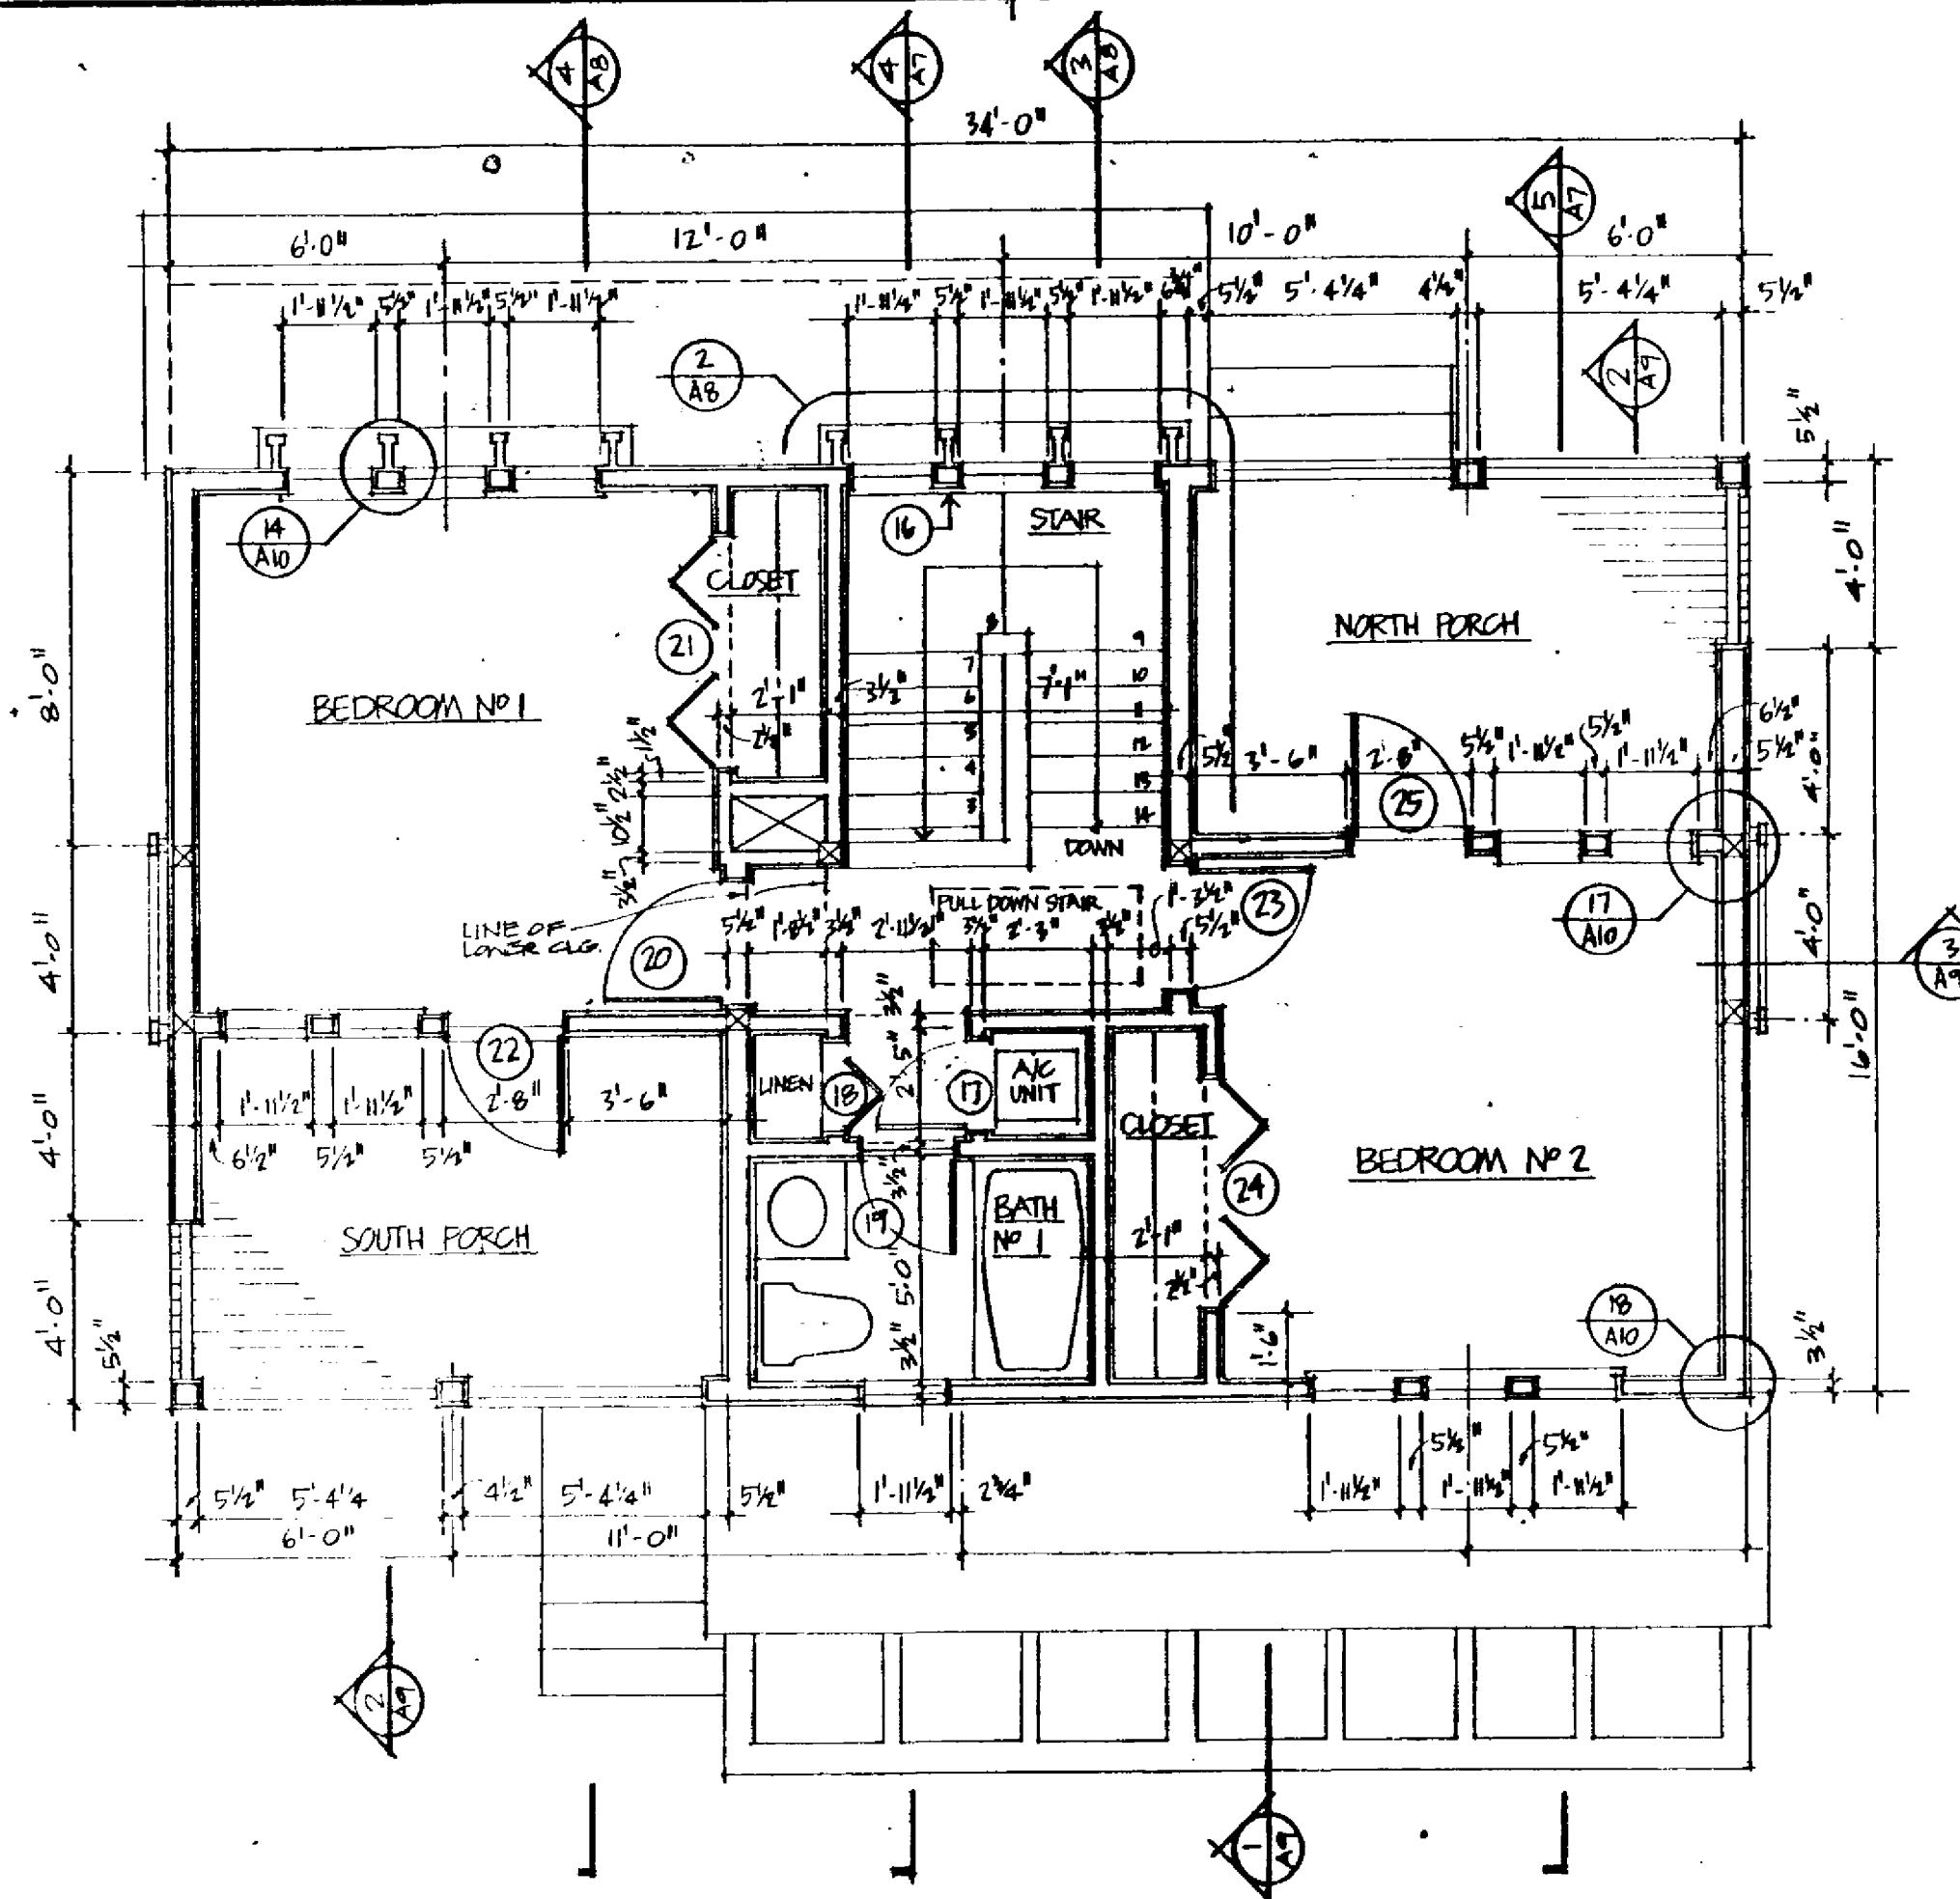
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No Date Description By

Drawing Title:

FLOOR
PLANS

Drawing Number

A-3

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PHASE I EXPANSION: MASTER BEDROOM SUITE

ALTERNATE LAUNDRY PLAN
ALTERNATE THIRD FLOOR: 3RD & 4TH
BEDROOMS & 2ND BATH


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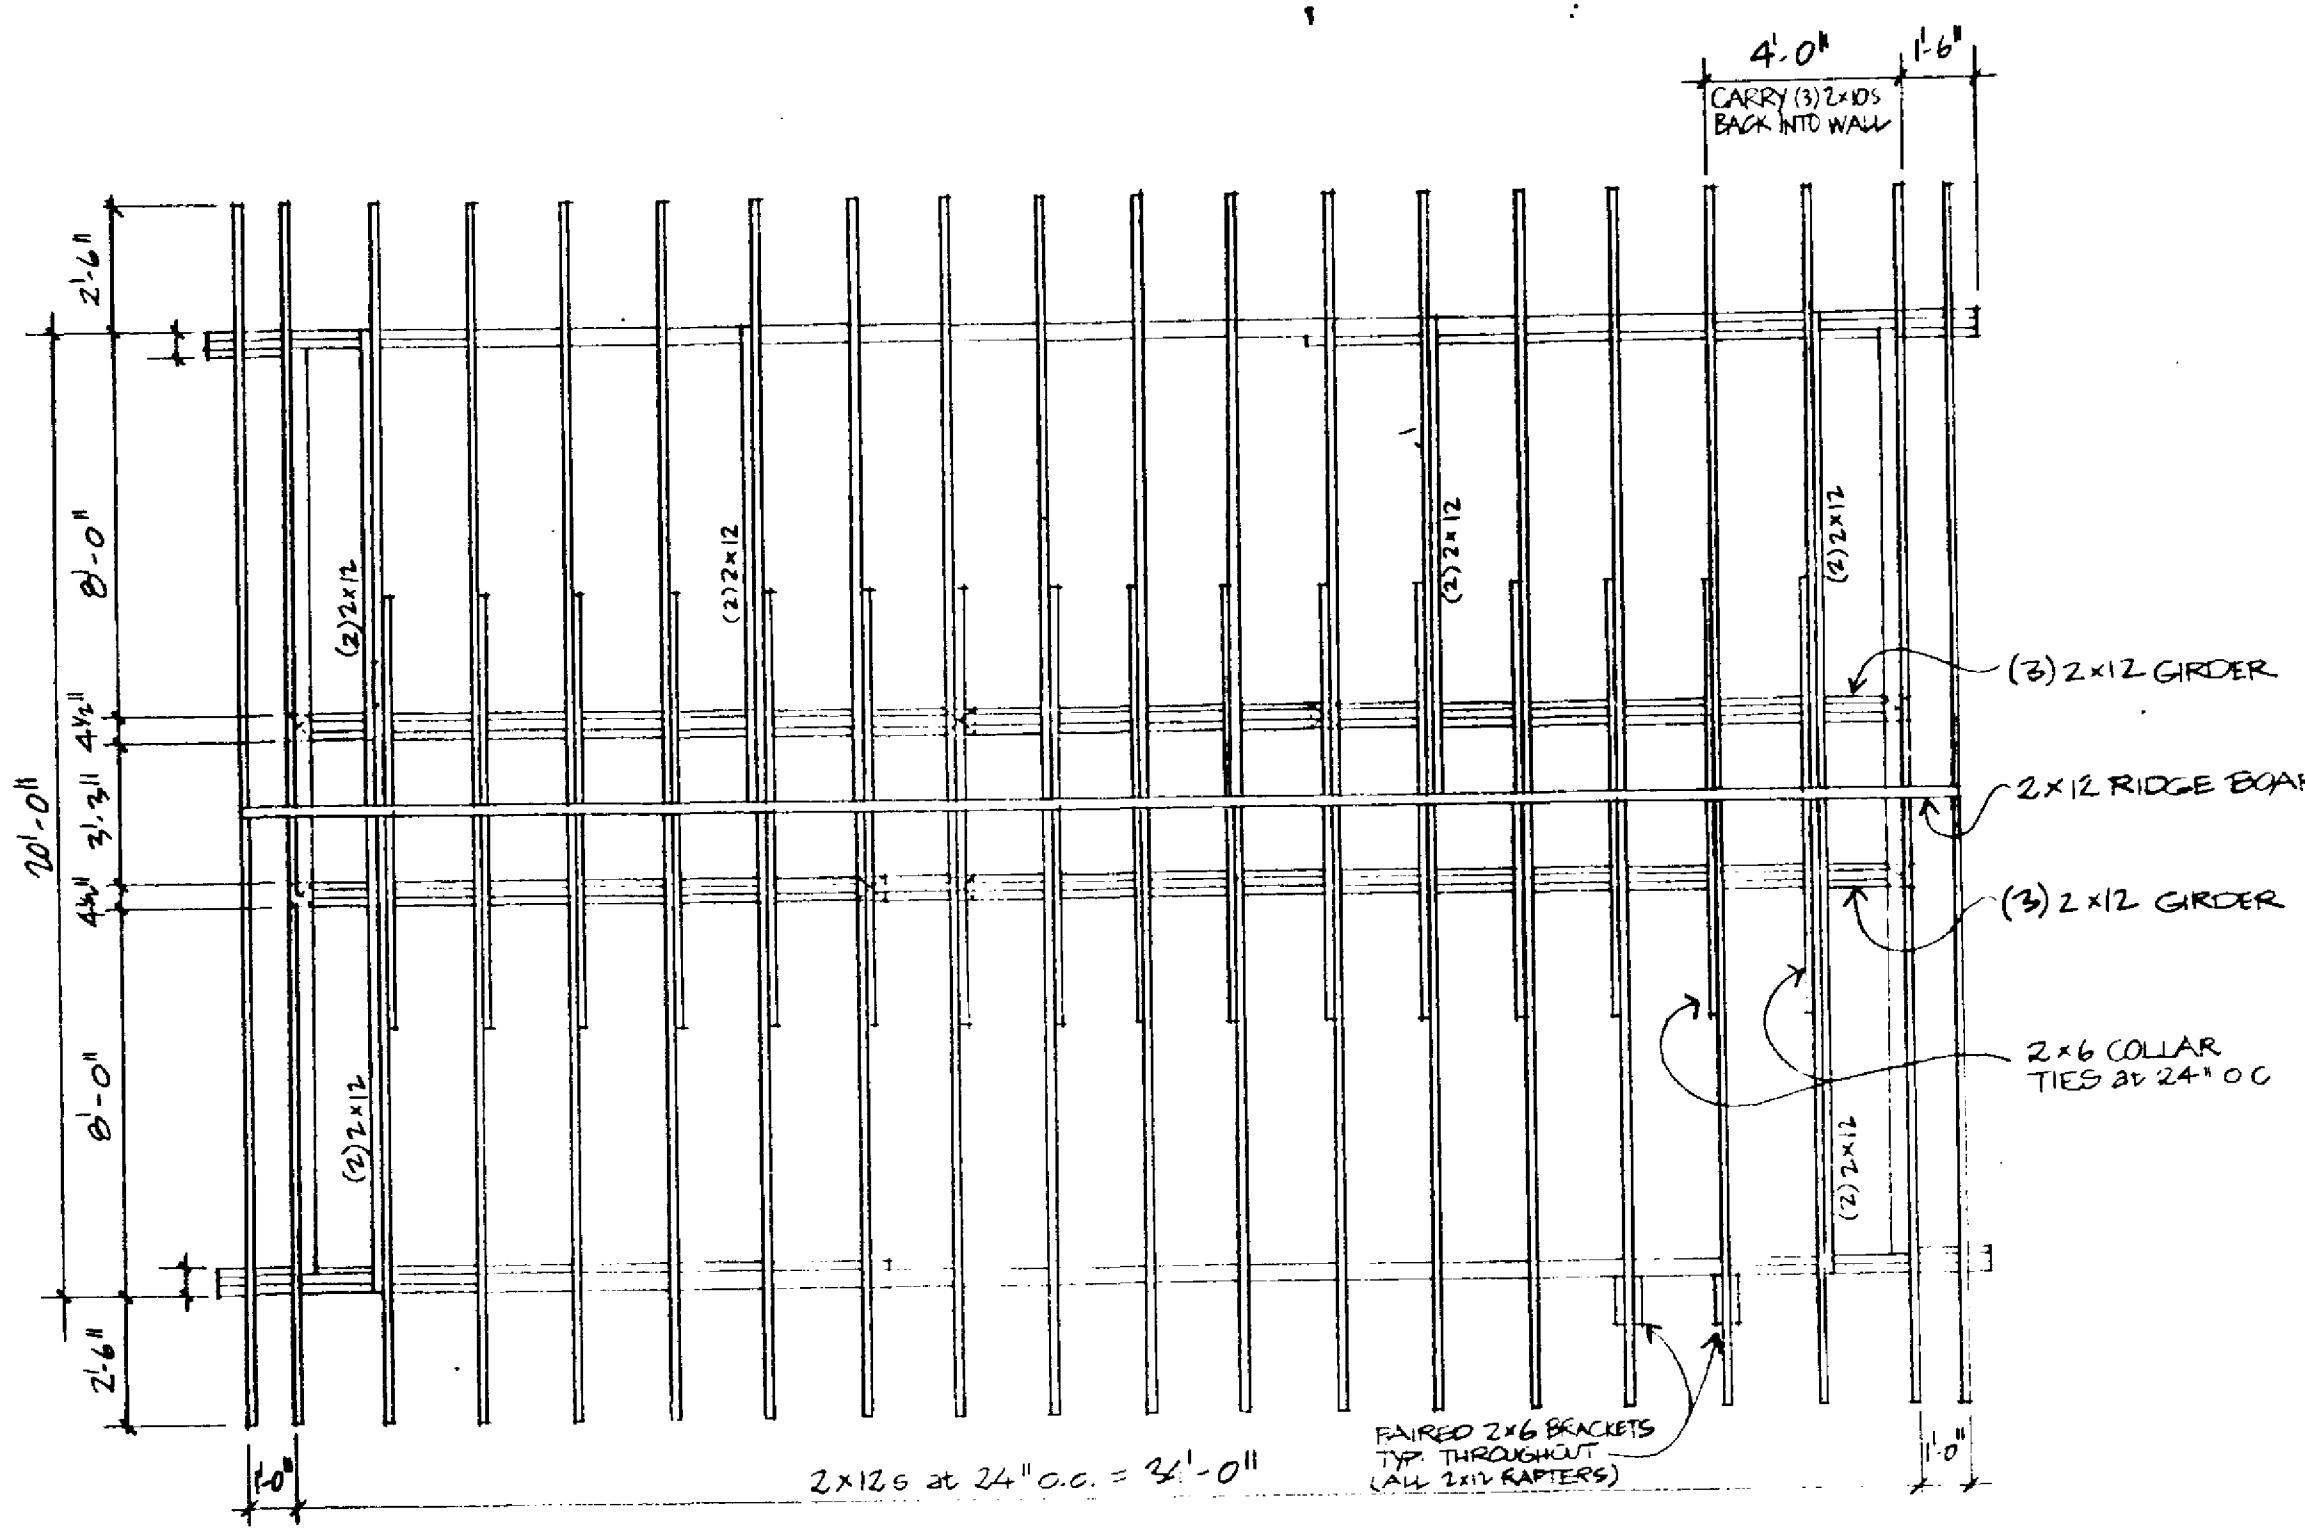
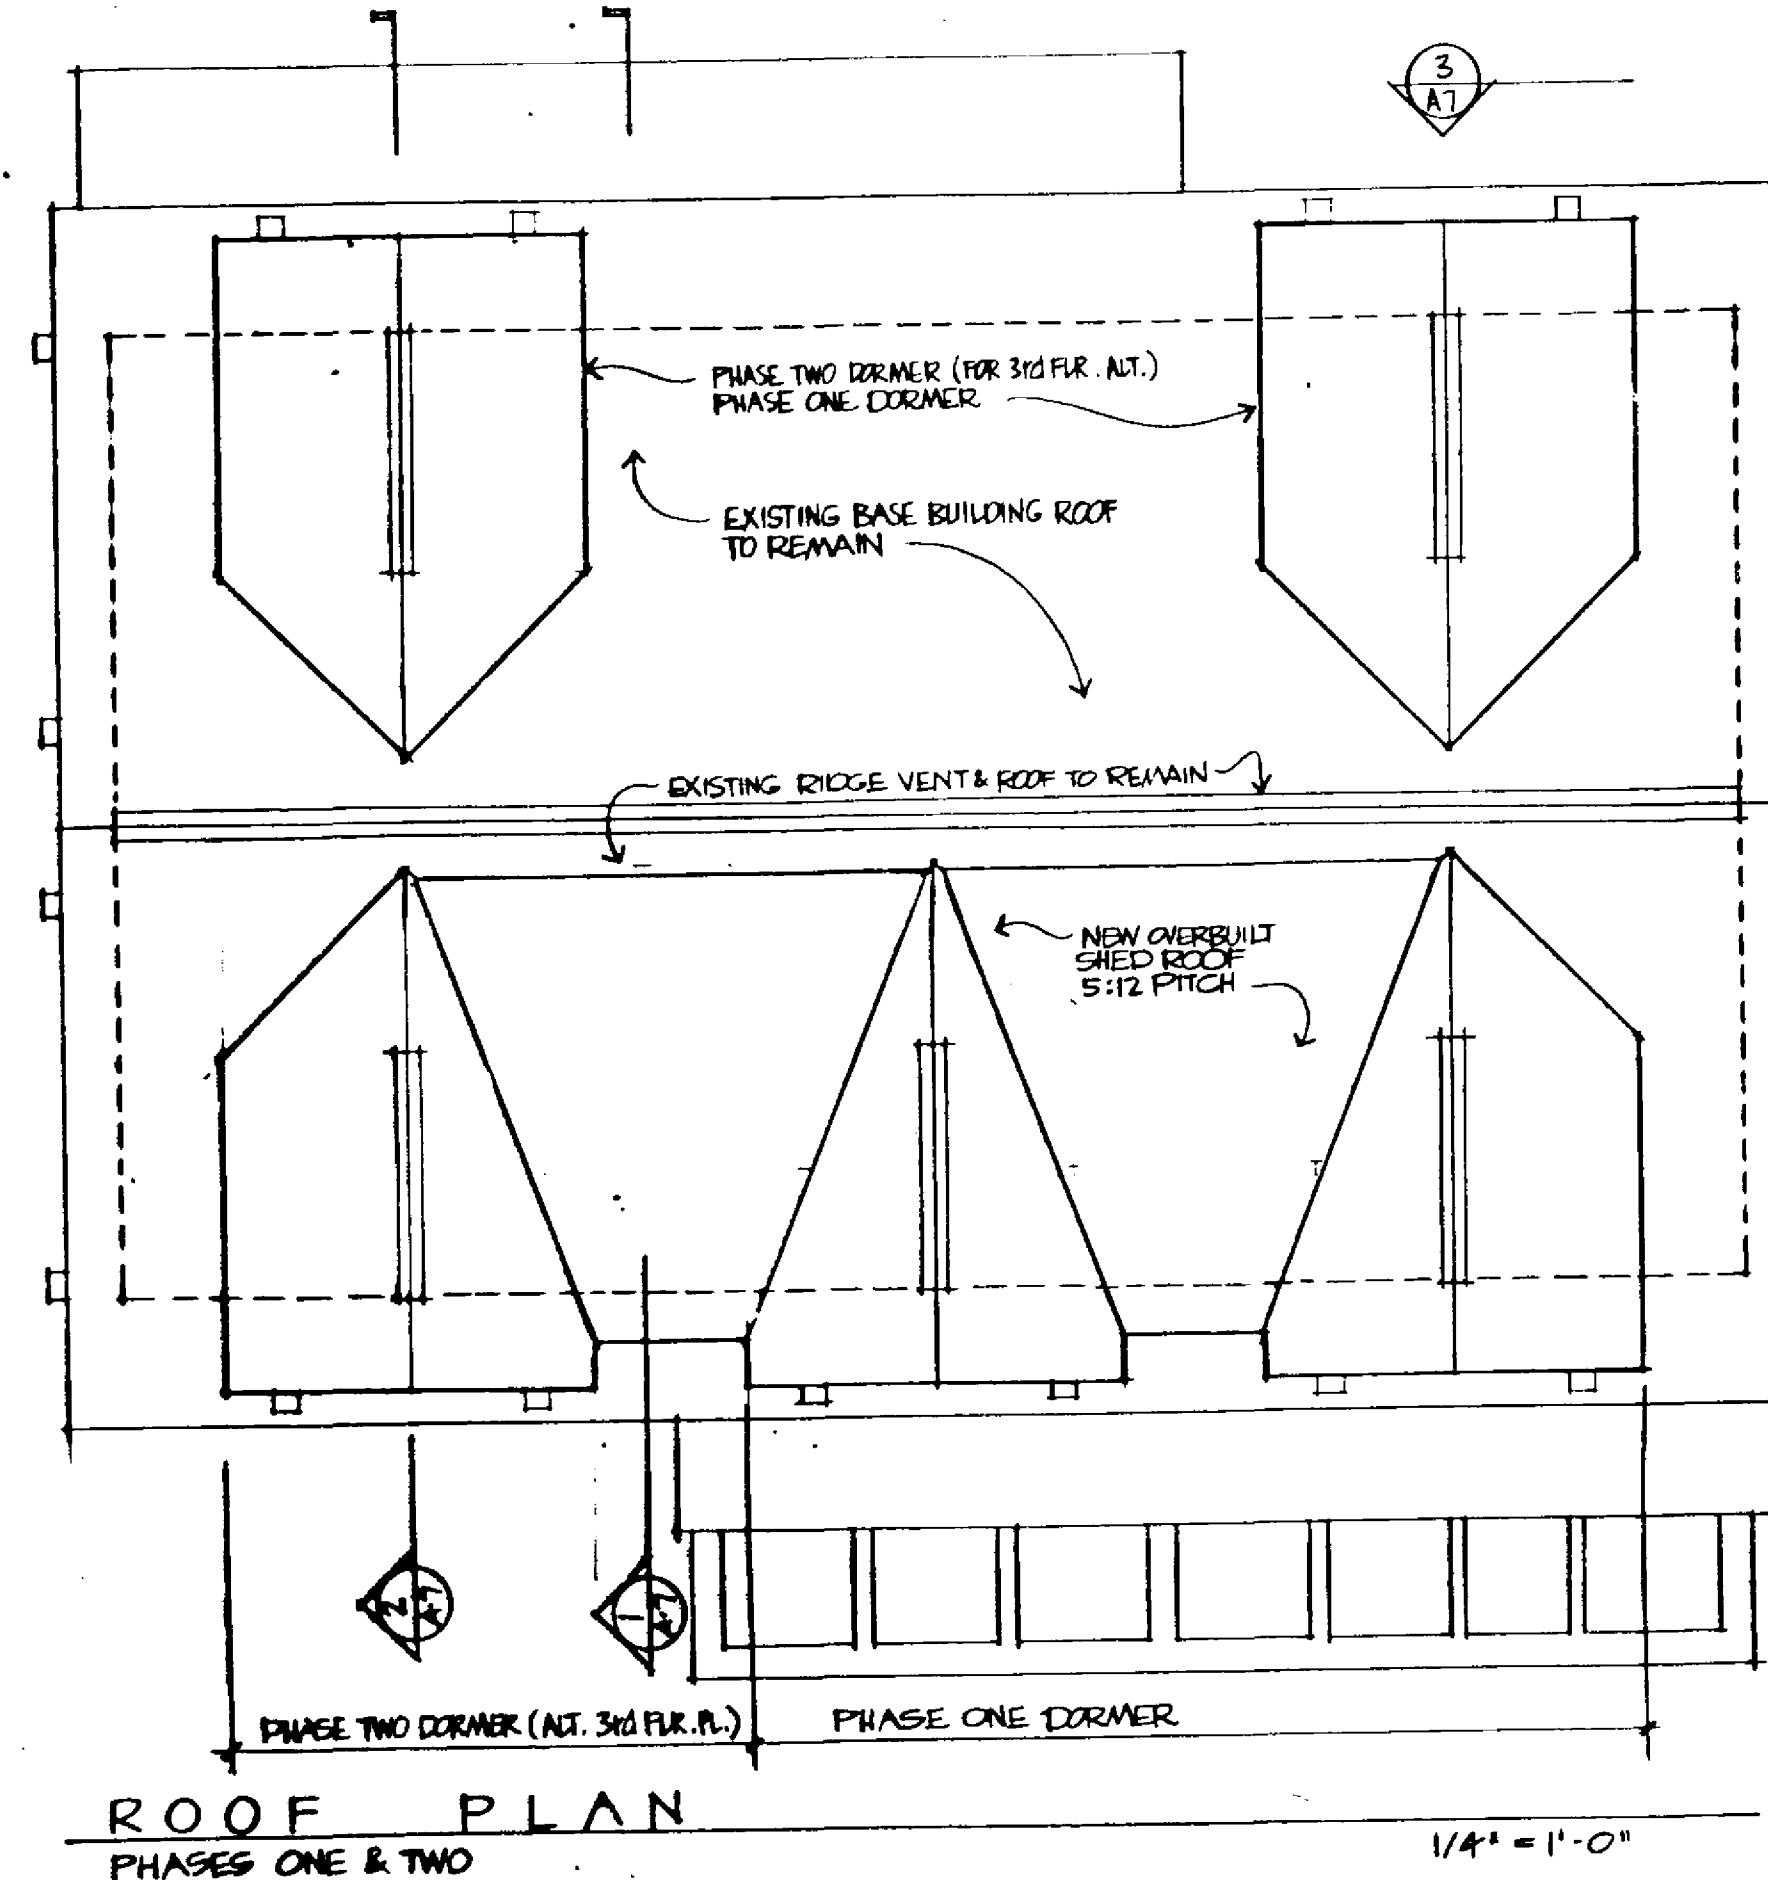
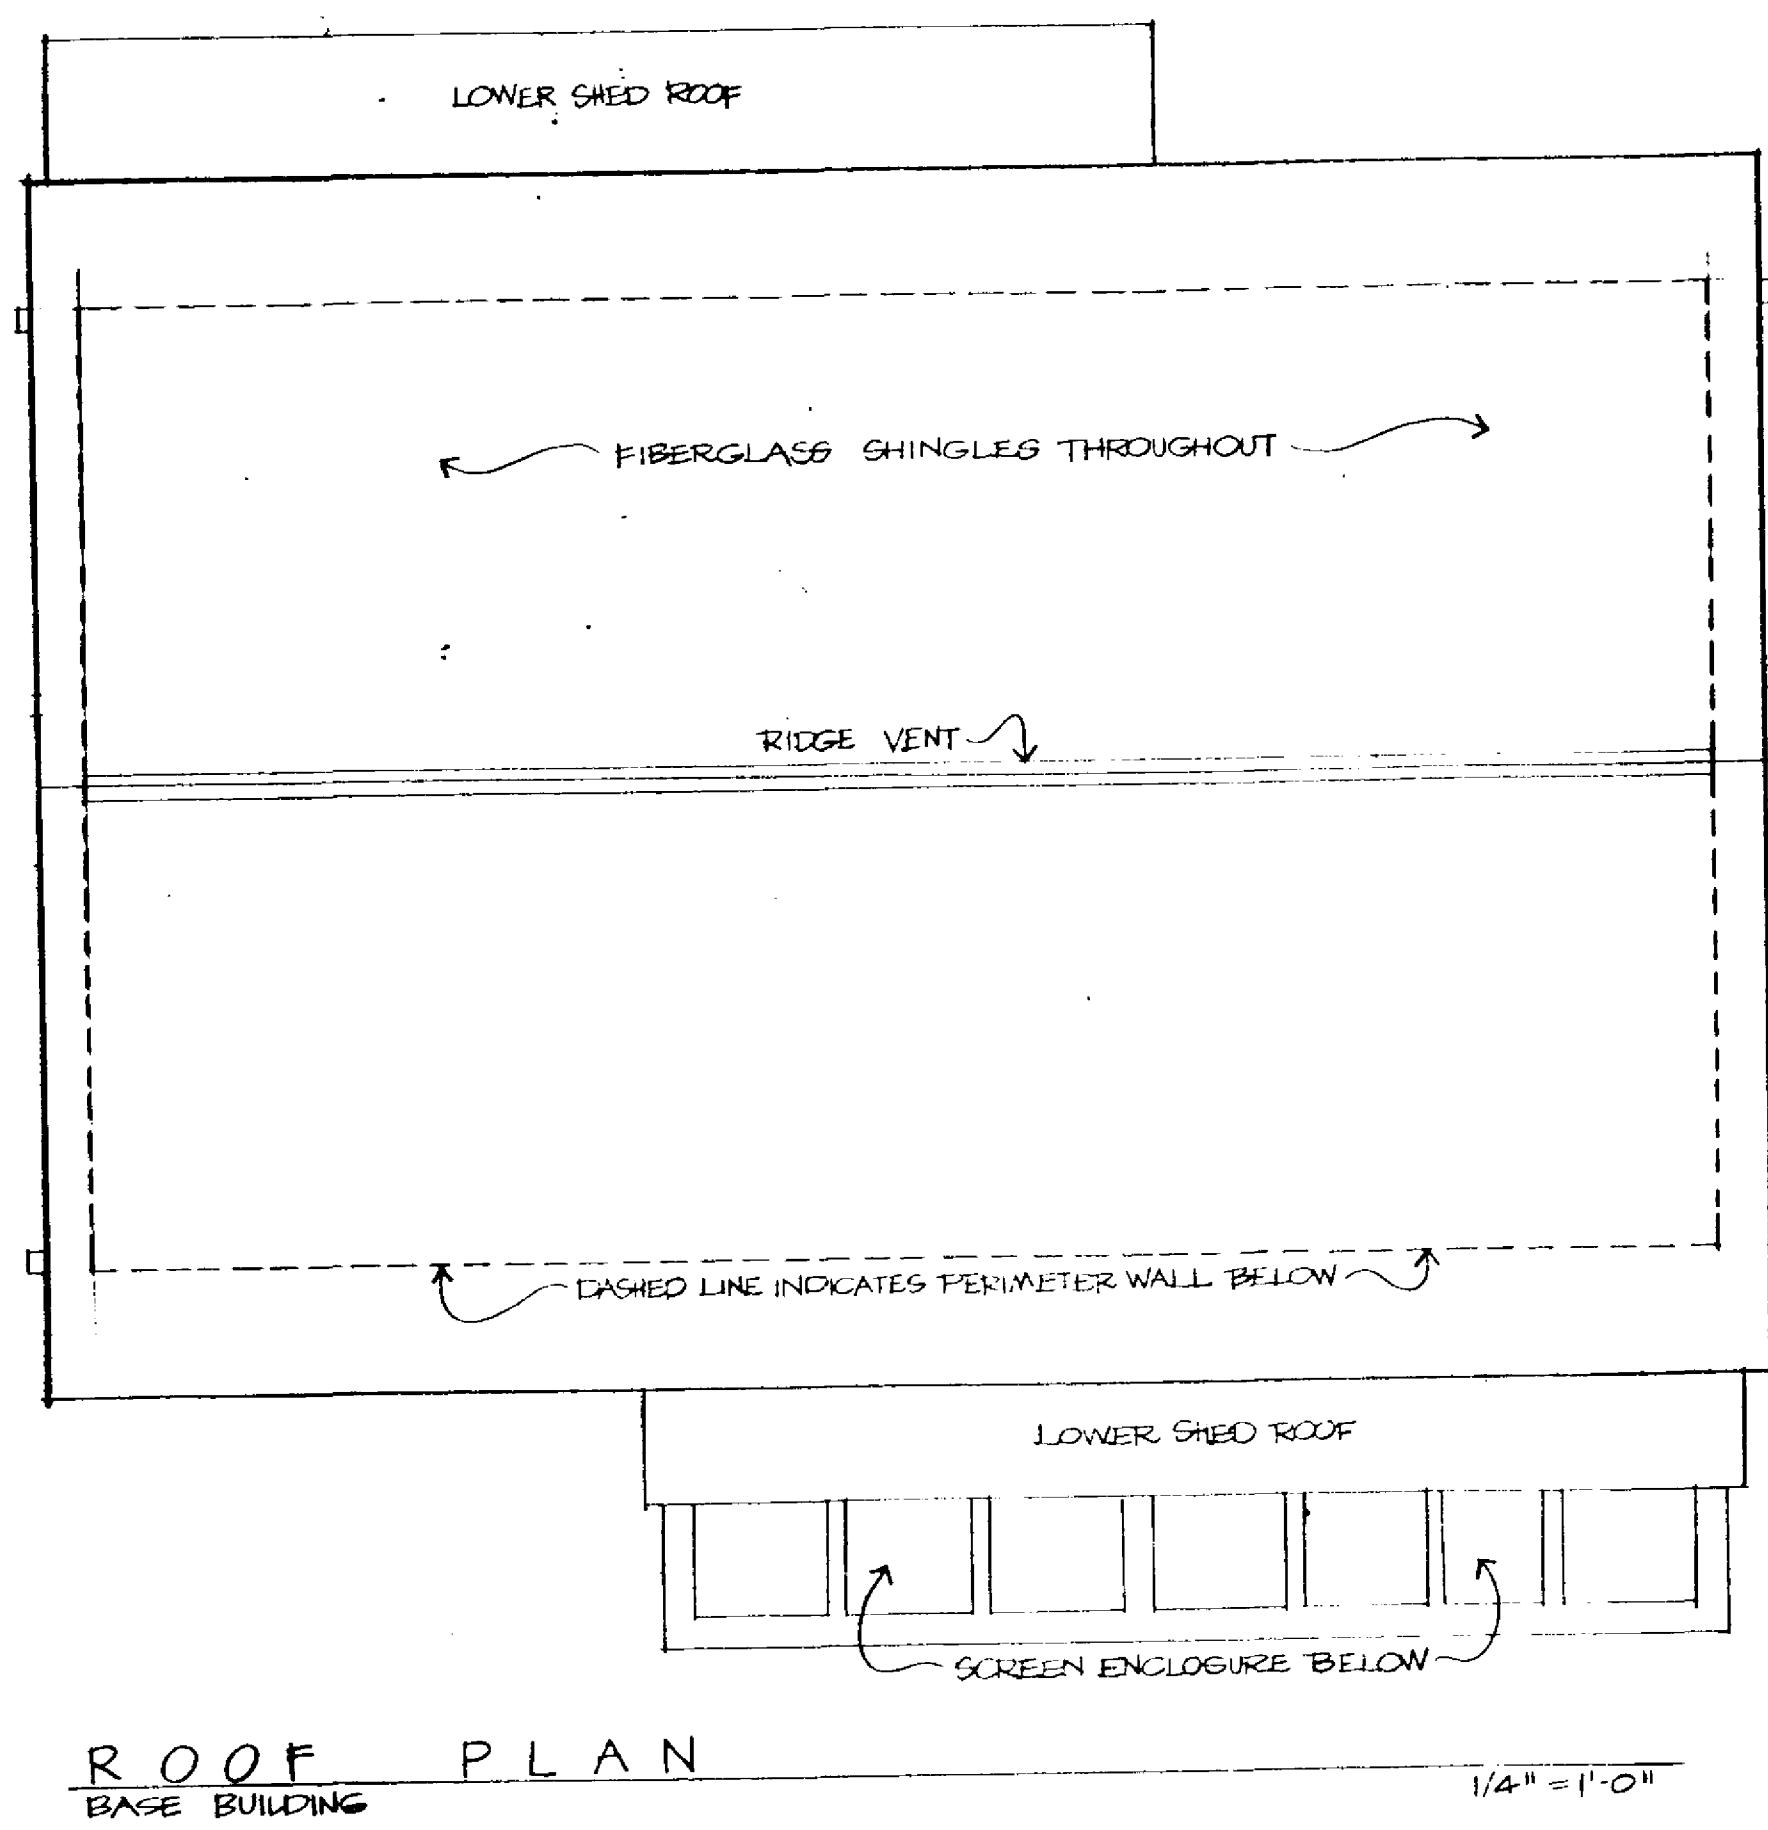
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**ROOF &
ROOF FRAMING
PLANS**


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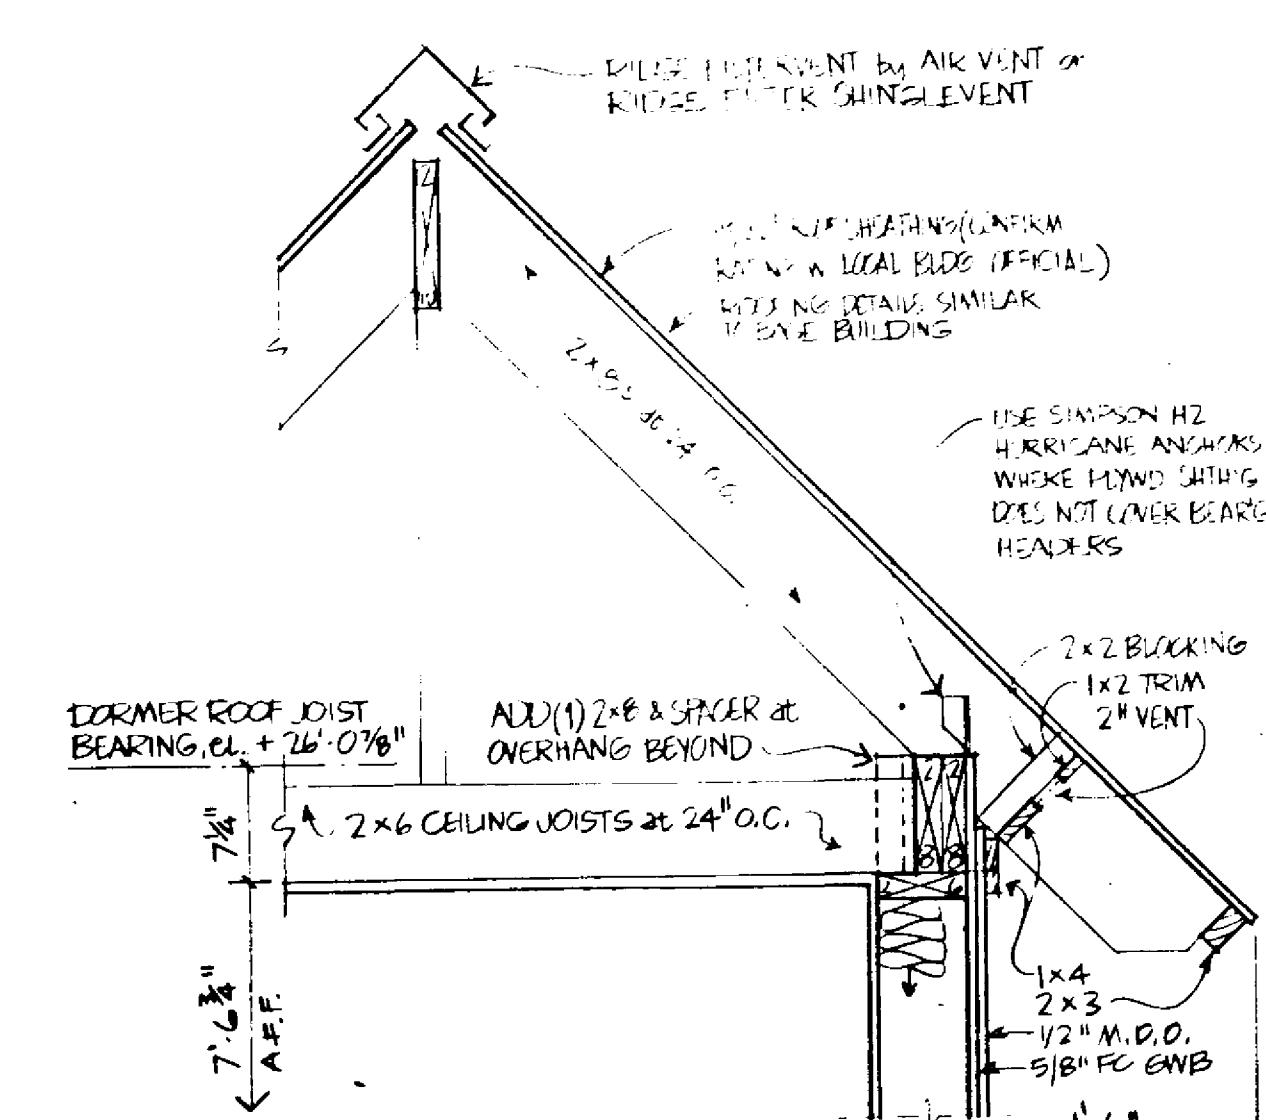
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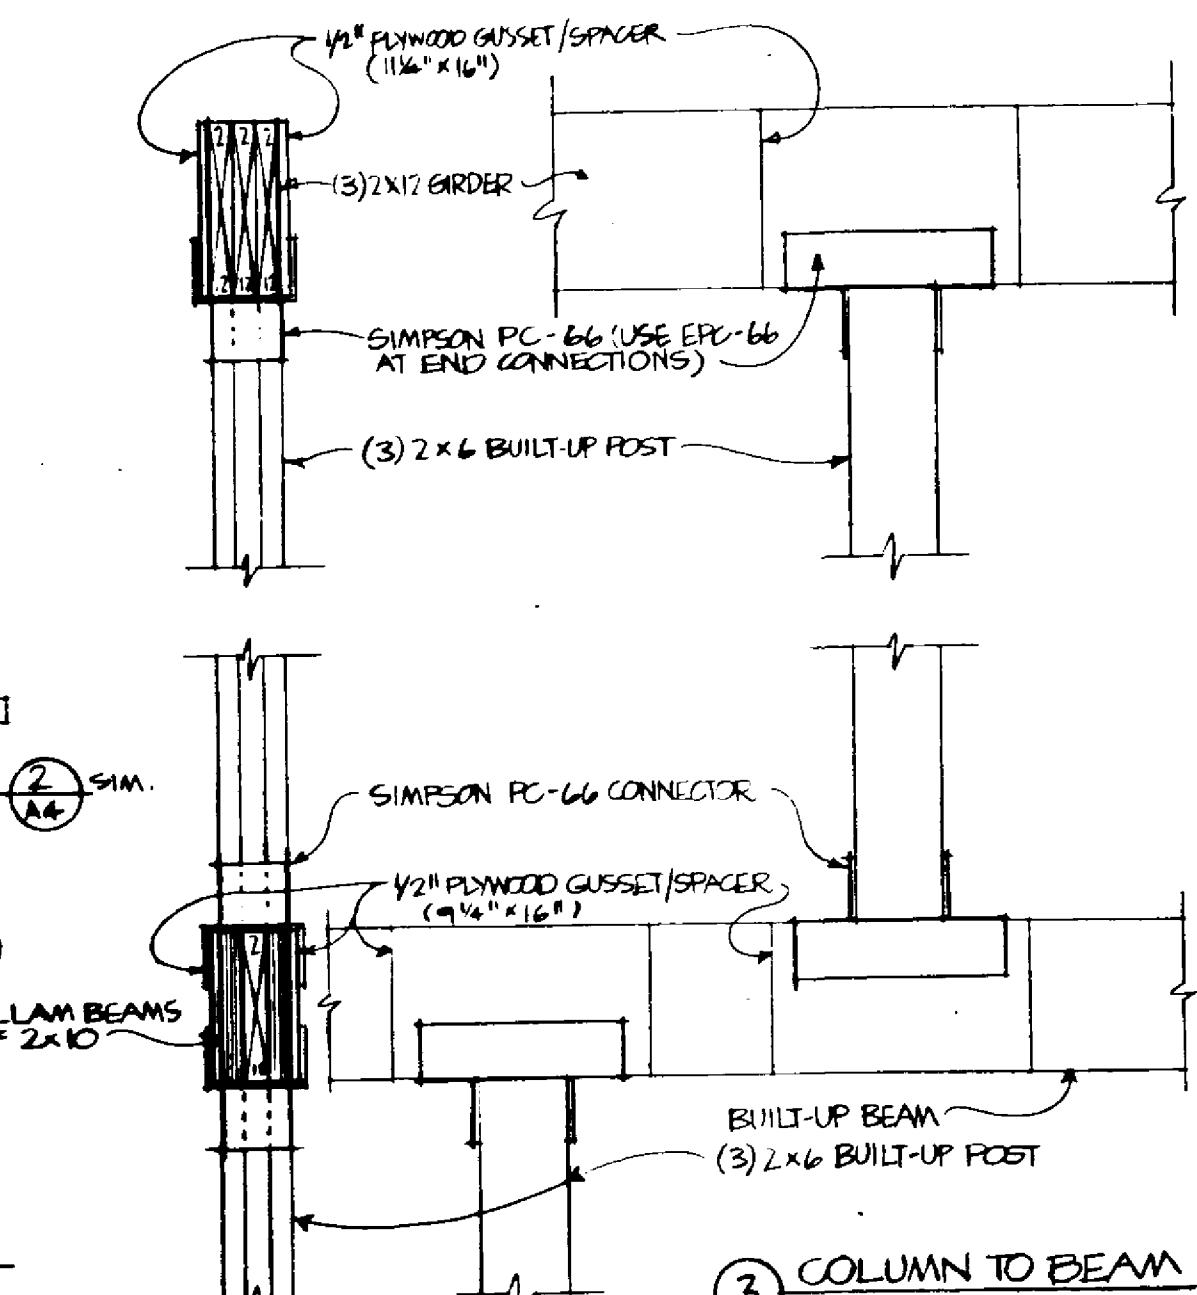
ROOF FRAMING PLAN
BASE BUILDING



ROOF FRAMING PLAN
PHASES ONE & TWO

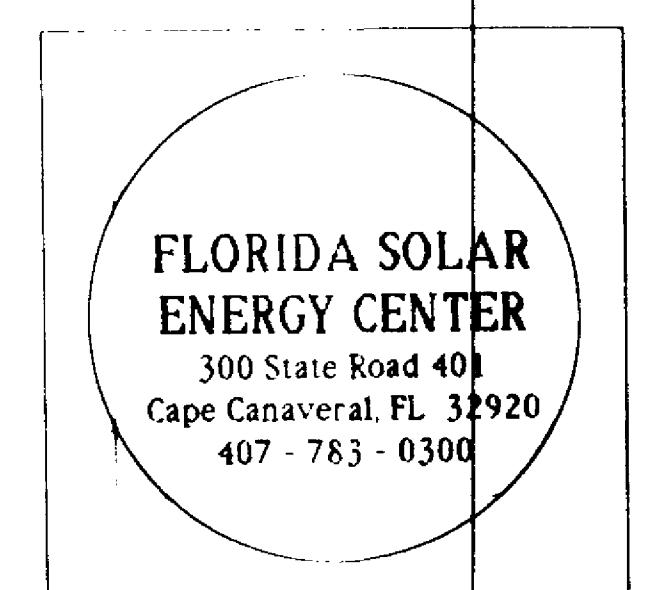

② PARTIAL DORMER SECTION

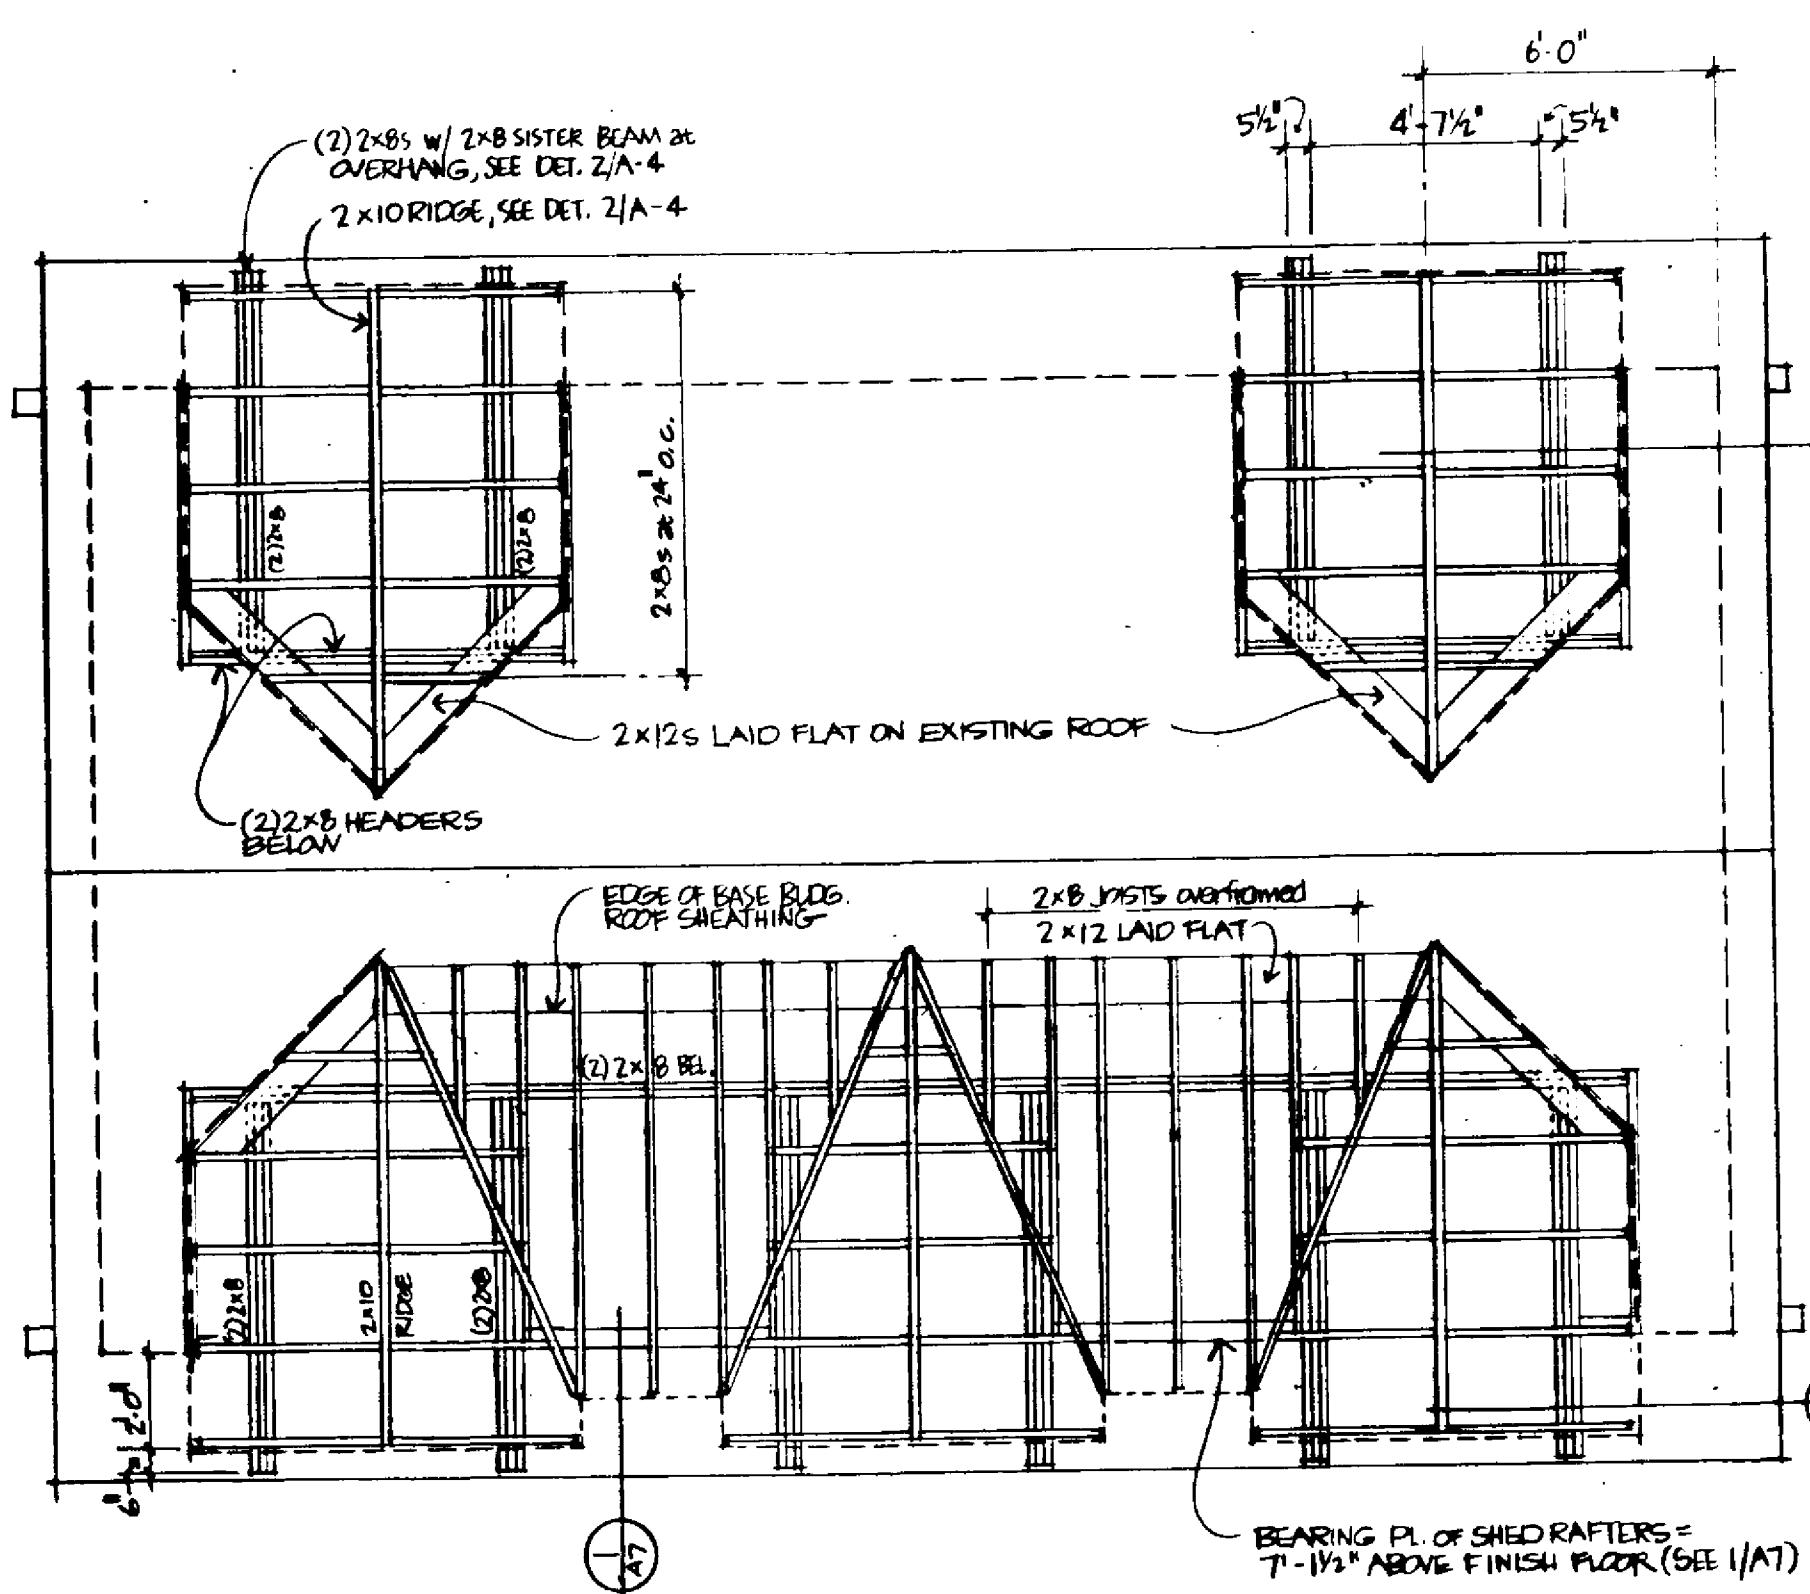

③ COLUMN TO BEAM
1" = 1'-0"

ENERGY EFFICIENT AND AFFORDABLE HOME

**900 S. F. BASE
PHASE I EXPANSION: MASTER BEDROOM SUITE**


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ALTERNATE THIRD FLOOR: 3RD & 4TH
BEDROOMS & 2ND BATH**

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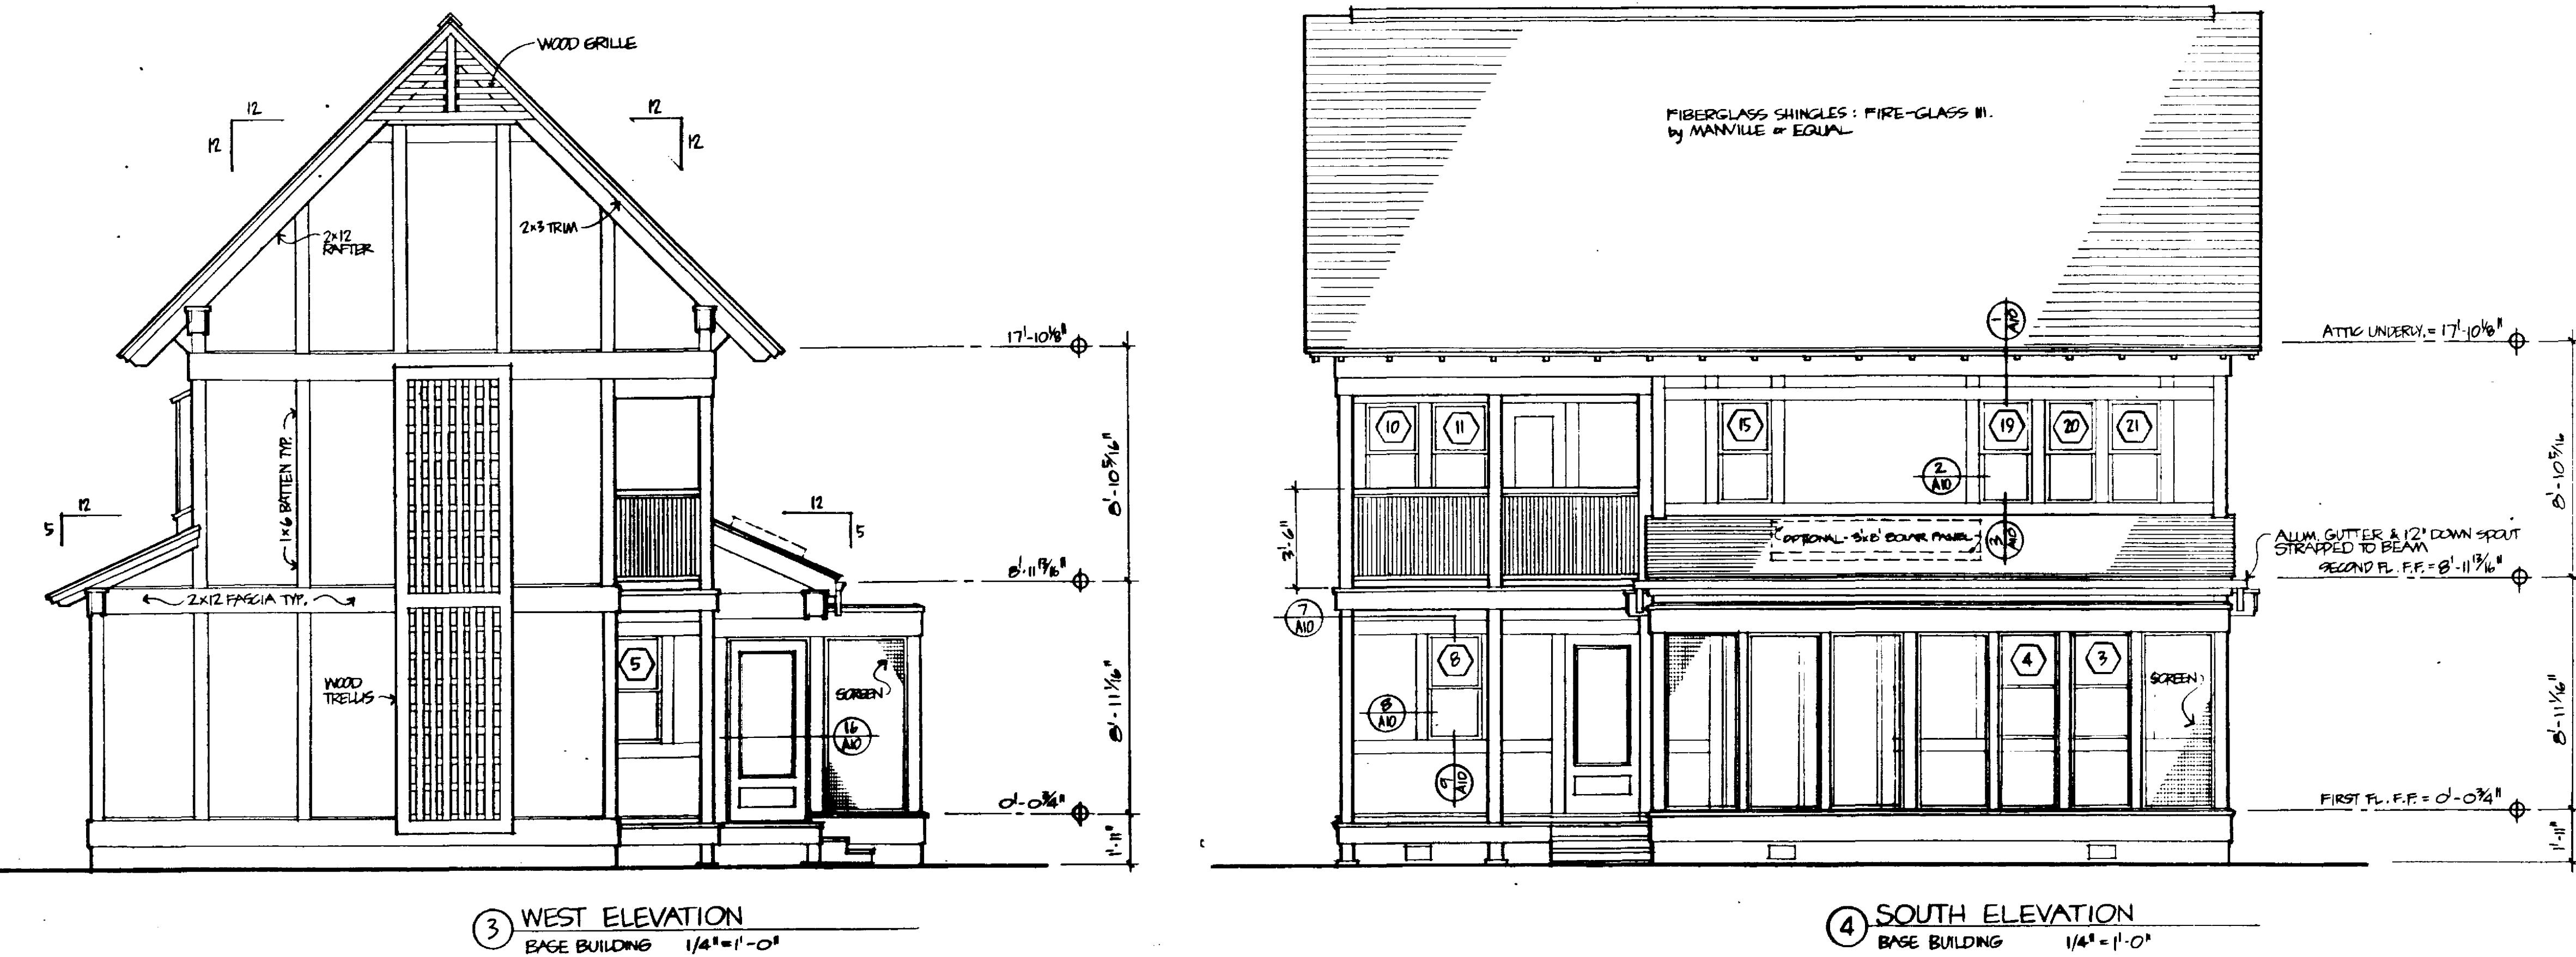
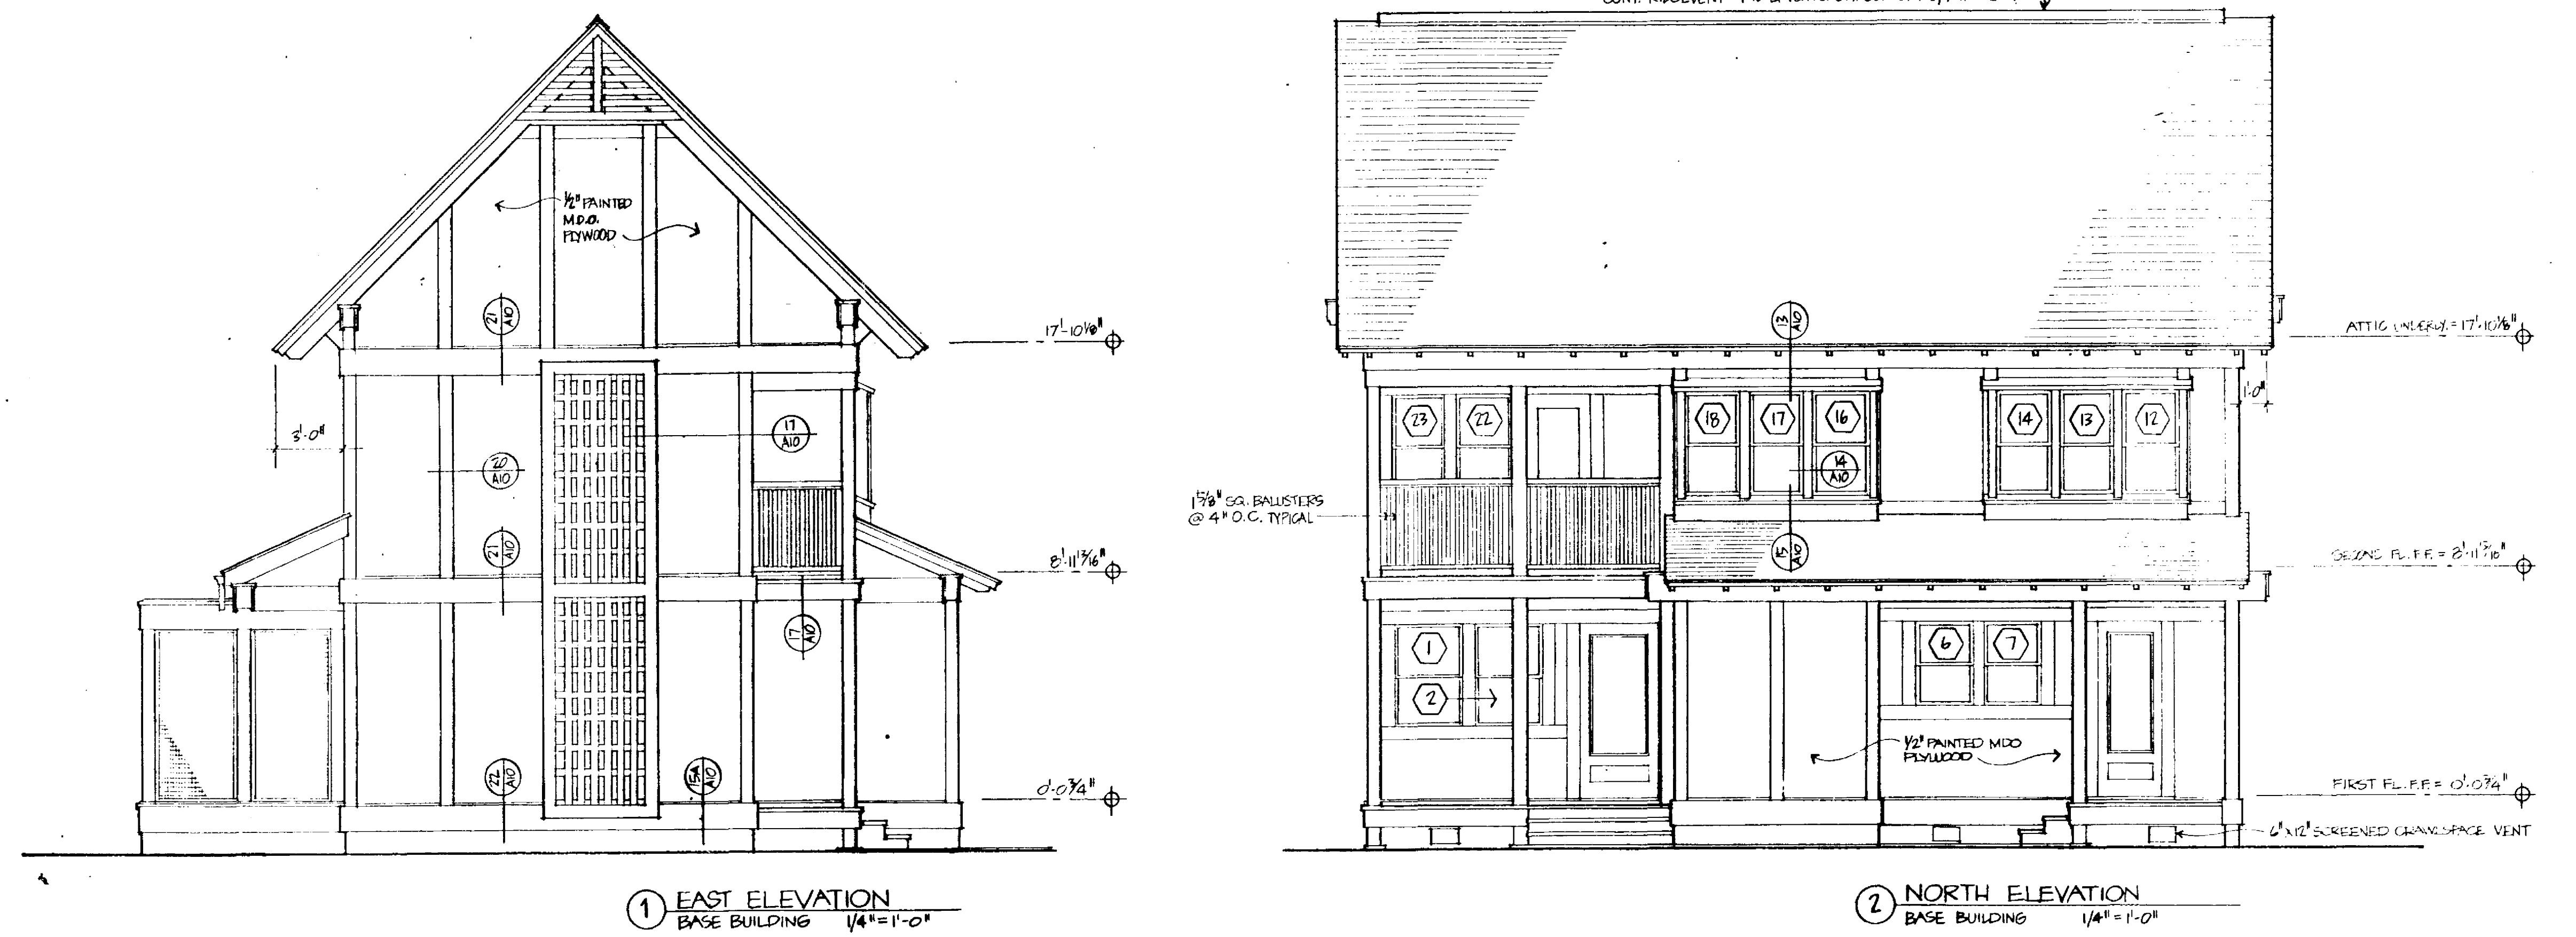
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Drawing Title:

EXTERIOR ELEVATIONS

— 1 —

A-5

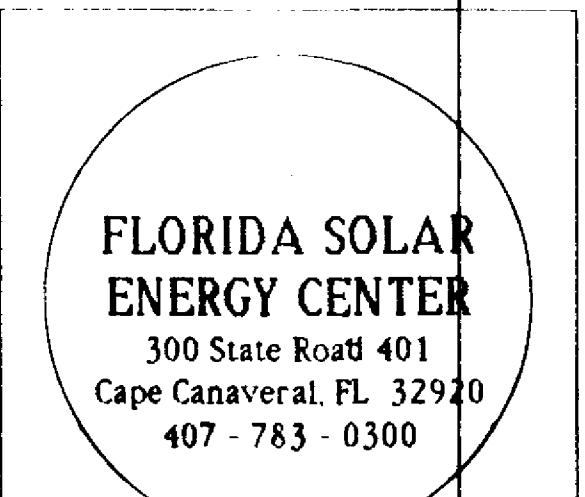

ENERGY EFFICIENT AND AFFORDABLE HOME

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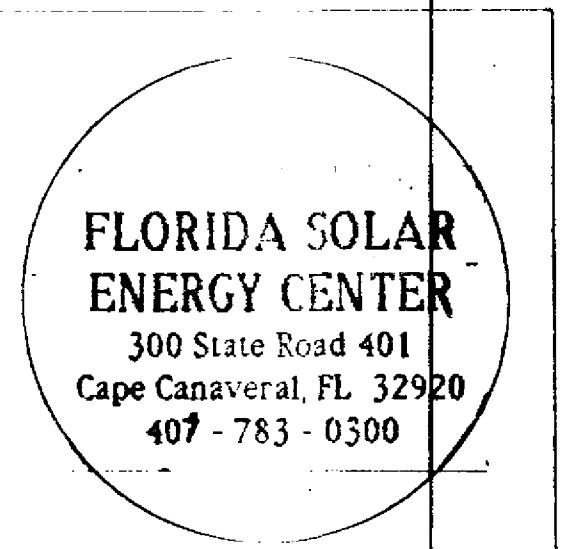
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ALTERNATE THIRD FLOOR: 3RD & 4TH
BEDROOMS & 2ND BATH**

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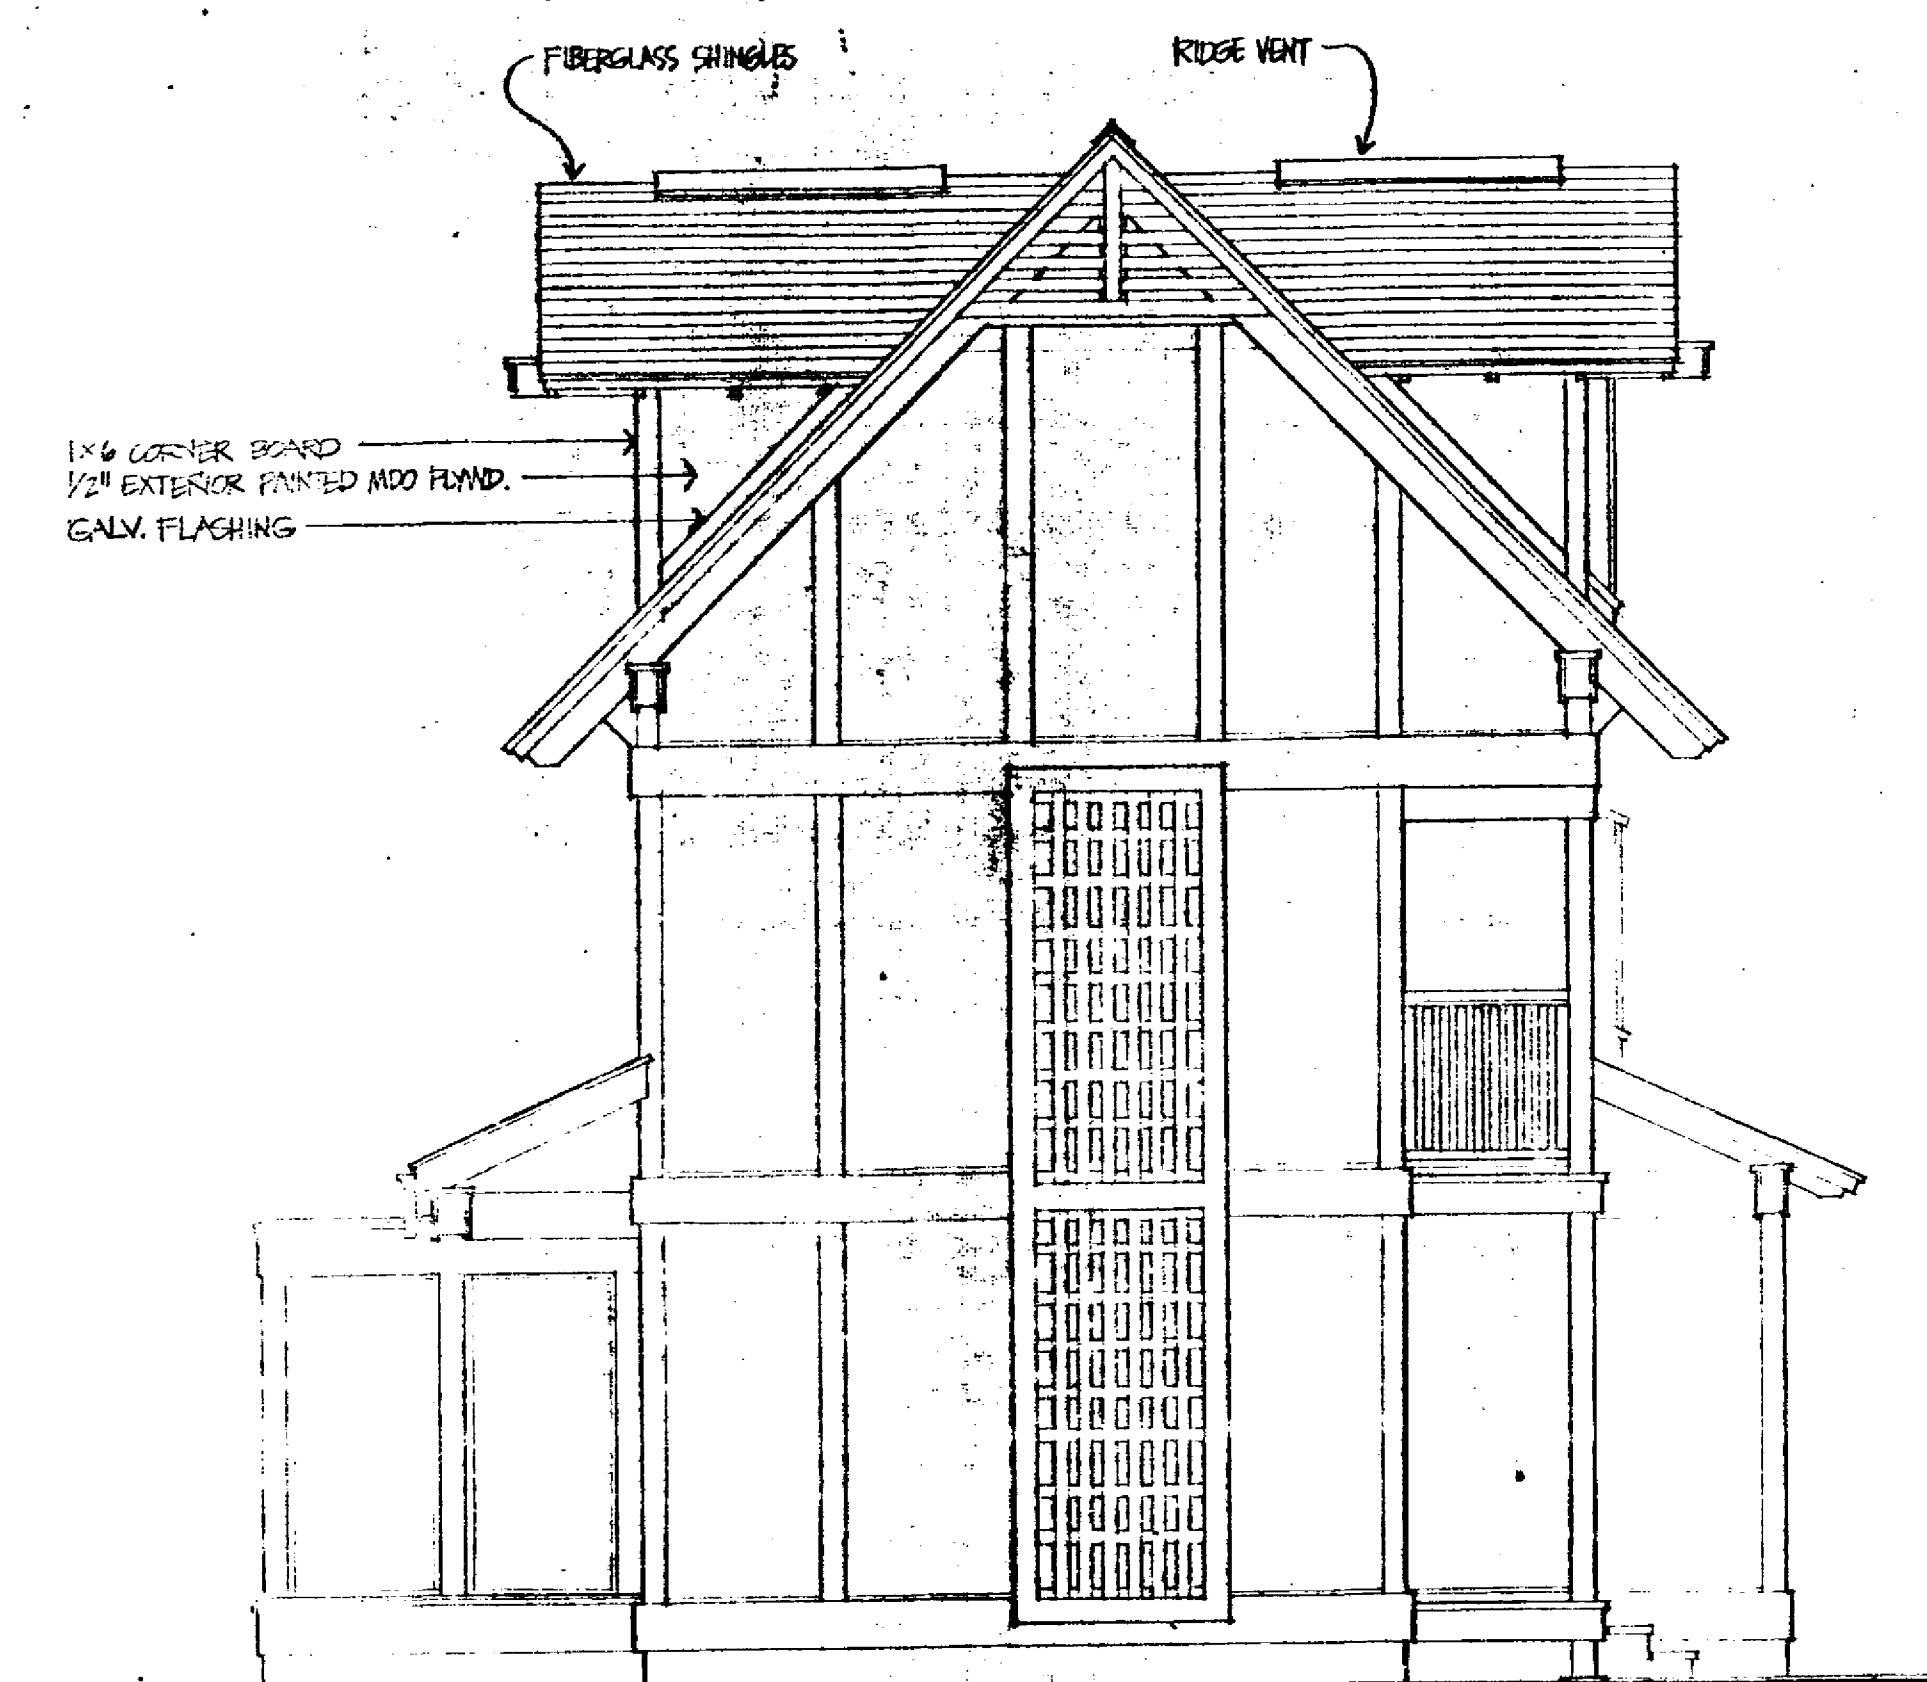
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PHASE 1. & 2 EXTERIOR ELEVATIONS

Drawing Number .

A-6

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EAST ELEVATION



2 NORTH ELEVATION
PHASE ONE & TWO 1/4" = 1'-0"



4 **SOUTH ELEVATION**
PAGE ONE & TWO $1/4" = 1'-0"$

ENERGY EFFICIENT AND AFFORDABLE HOME

900 S. F. BASE

BASE | EXPANSION: MASTER BEDROOM SUITE

**ALTERNATE LAUNDRY PLAN
ALTERNATE THIRD FLOOR: 3RD & 4TH
BEDROOMS & 2ND BATH**

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Designers

Im Street
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No. 9122

By B. EDGERLY

d By:

10-17-91

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Date	Description	By
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ANSWER *What is the name of the author of the book?*


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ng Title:
ILDING SECTION &
ALL SECTION &
AIR DETAILS

Referring Number:

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ENERGY EFFICIENT AND AFFORDABLE HOME

BASE

BASE I EXPANSION: MASTER BEDROOM SUITE

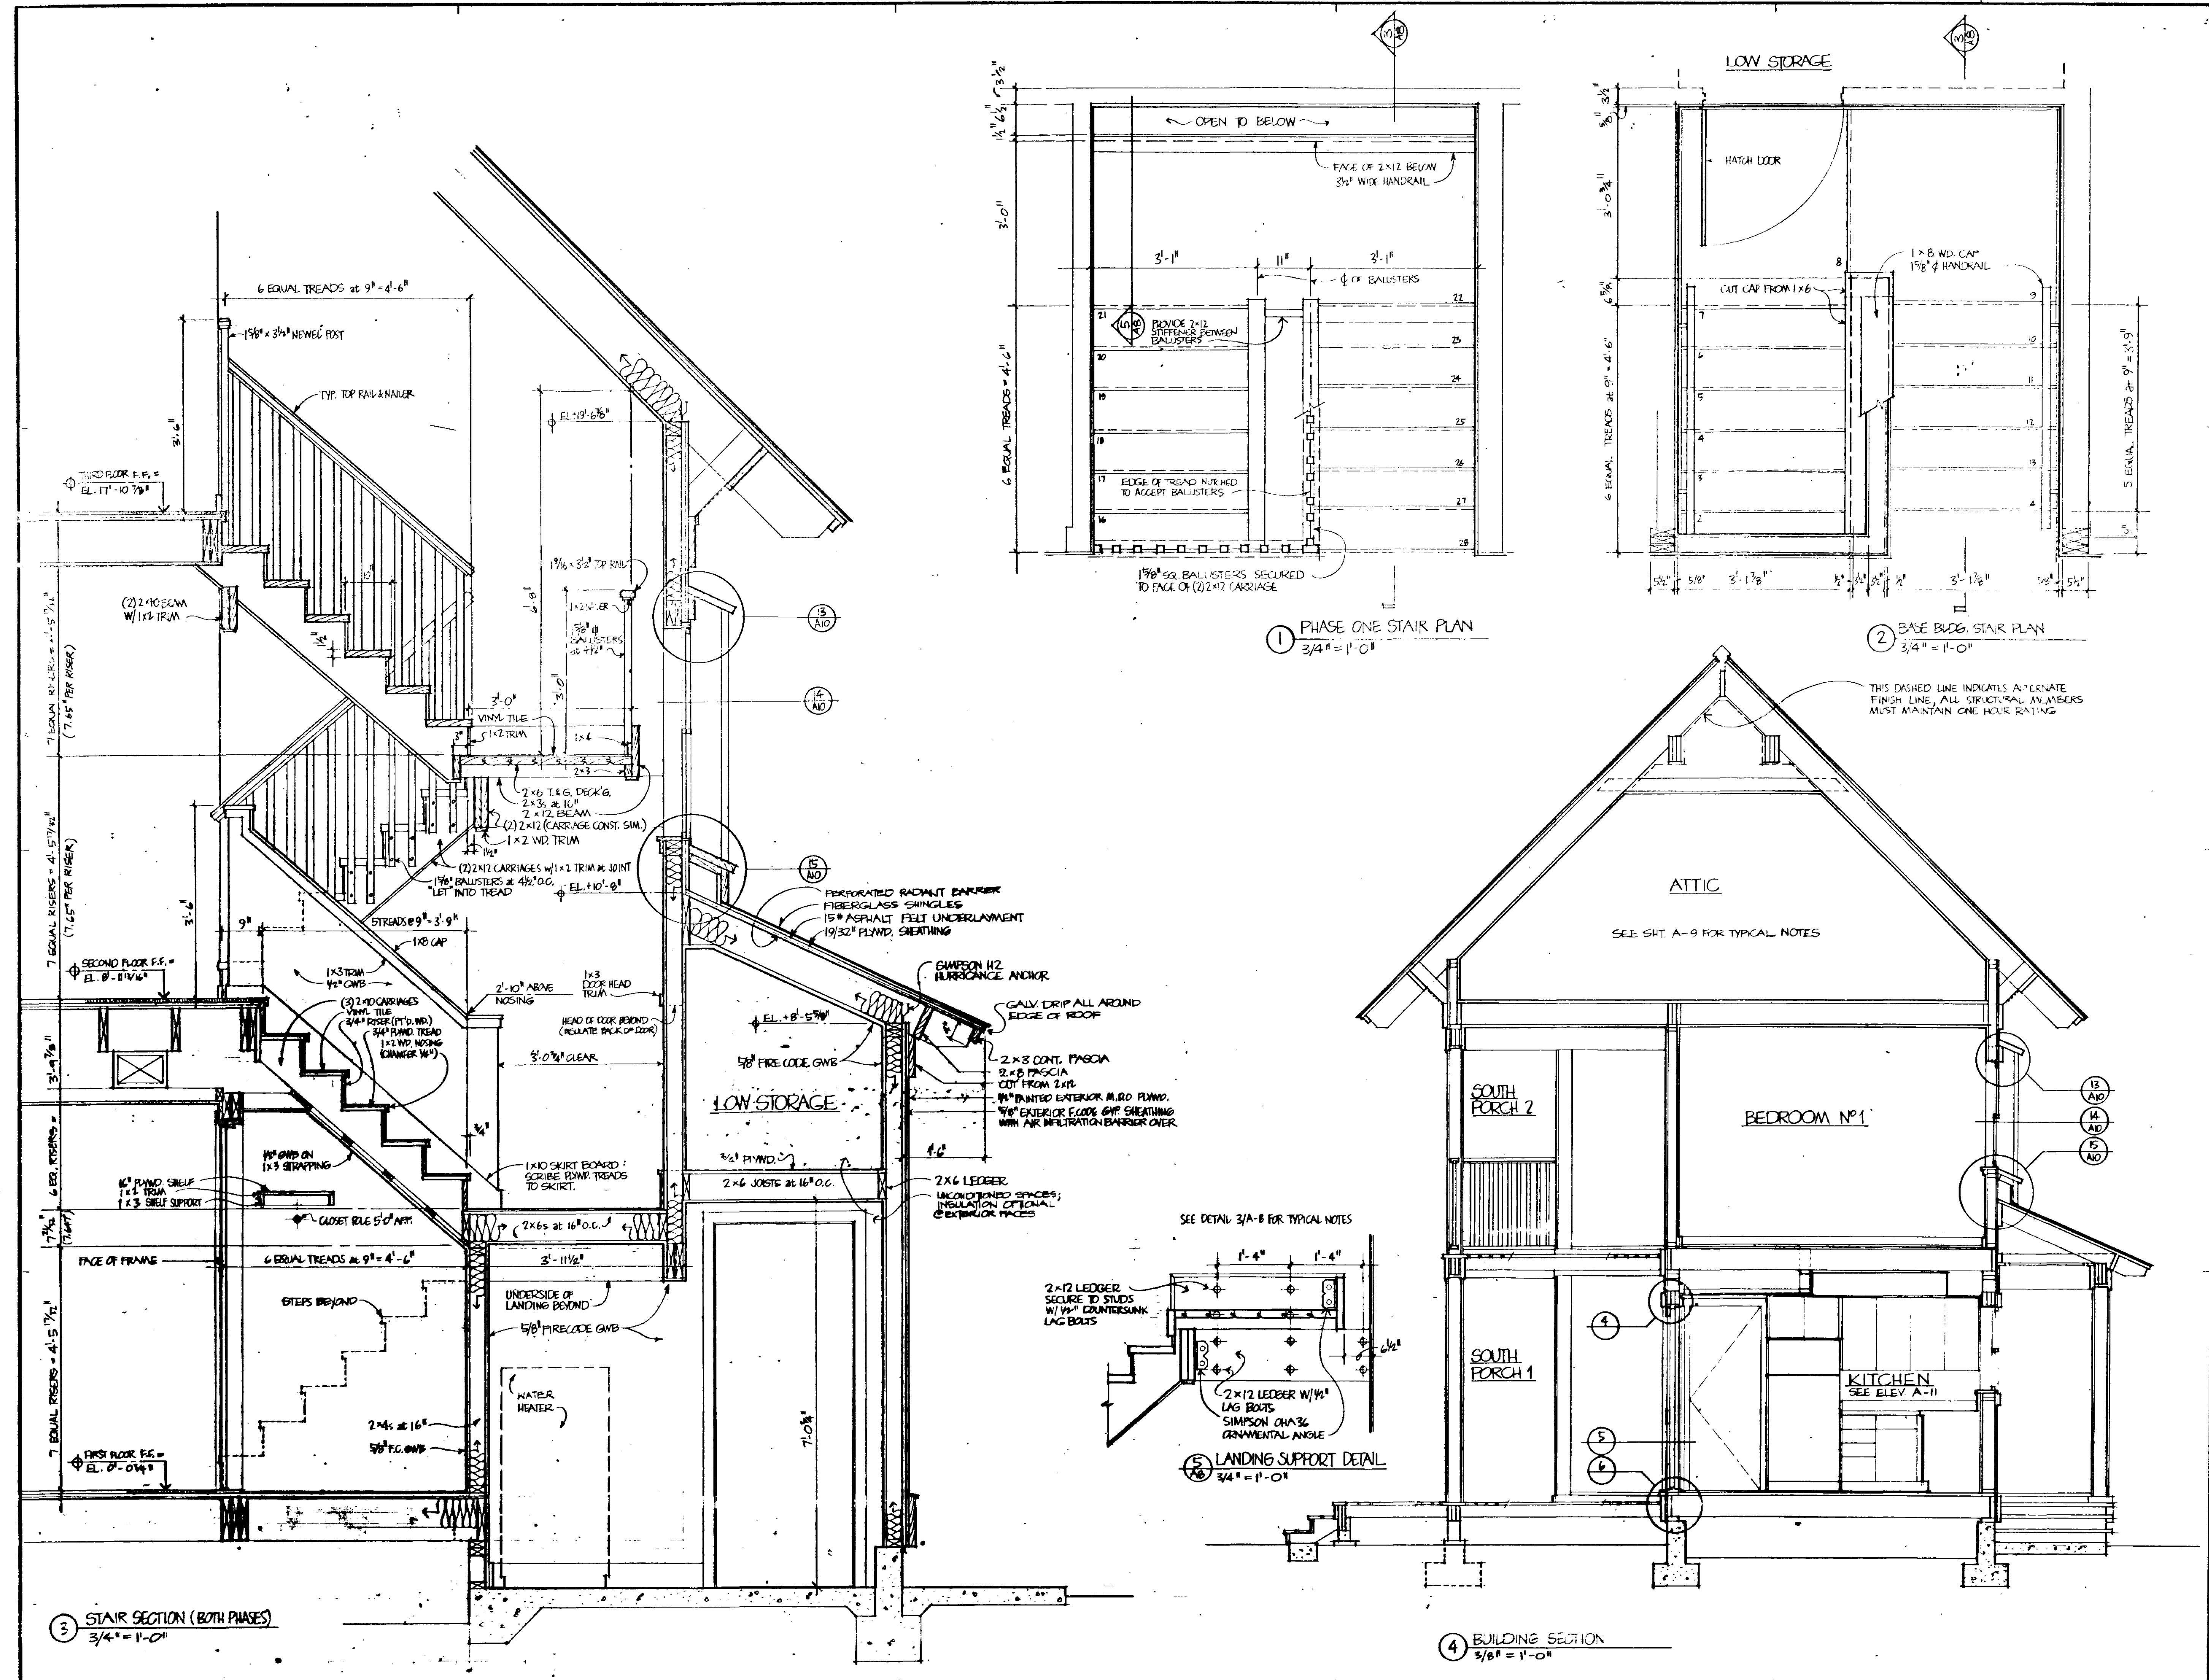**ALTERNATE LAUNDRY PLAN
NTRATE THIRD FLOOR: 3RD & 4TH
BEDROOMS & 2ND BATH**

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C O N S U L T I N G E N G I N E E R S 2 1 4 C O M M E R C I A L S
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checked By:

Due Date: 10-17-91

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Drawing Title:

TYPICAL WALL

WEE SECTIONS


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Drawing Number

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For more information about the study, please contact Dr. Michael J. Hwang at (310) 206-6500 or via email at mhwang@ucla.edu.



ENERGY EFFICIENT AND AFFORDABLE HOME

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PHASE I EXPANSION: MASTER BEDROOM SUITE

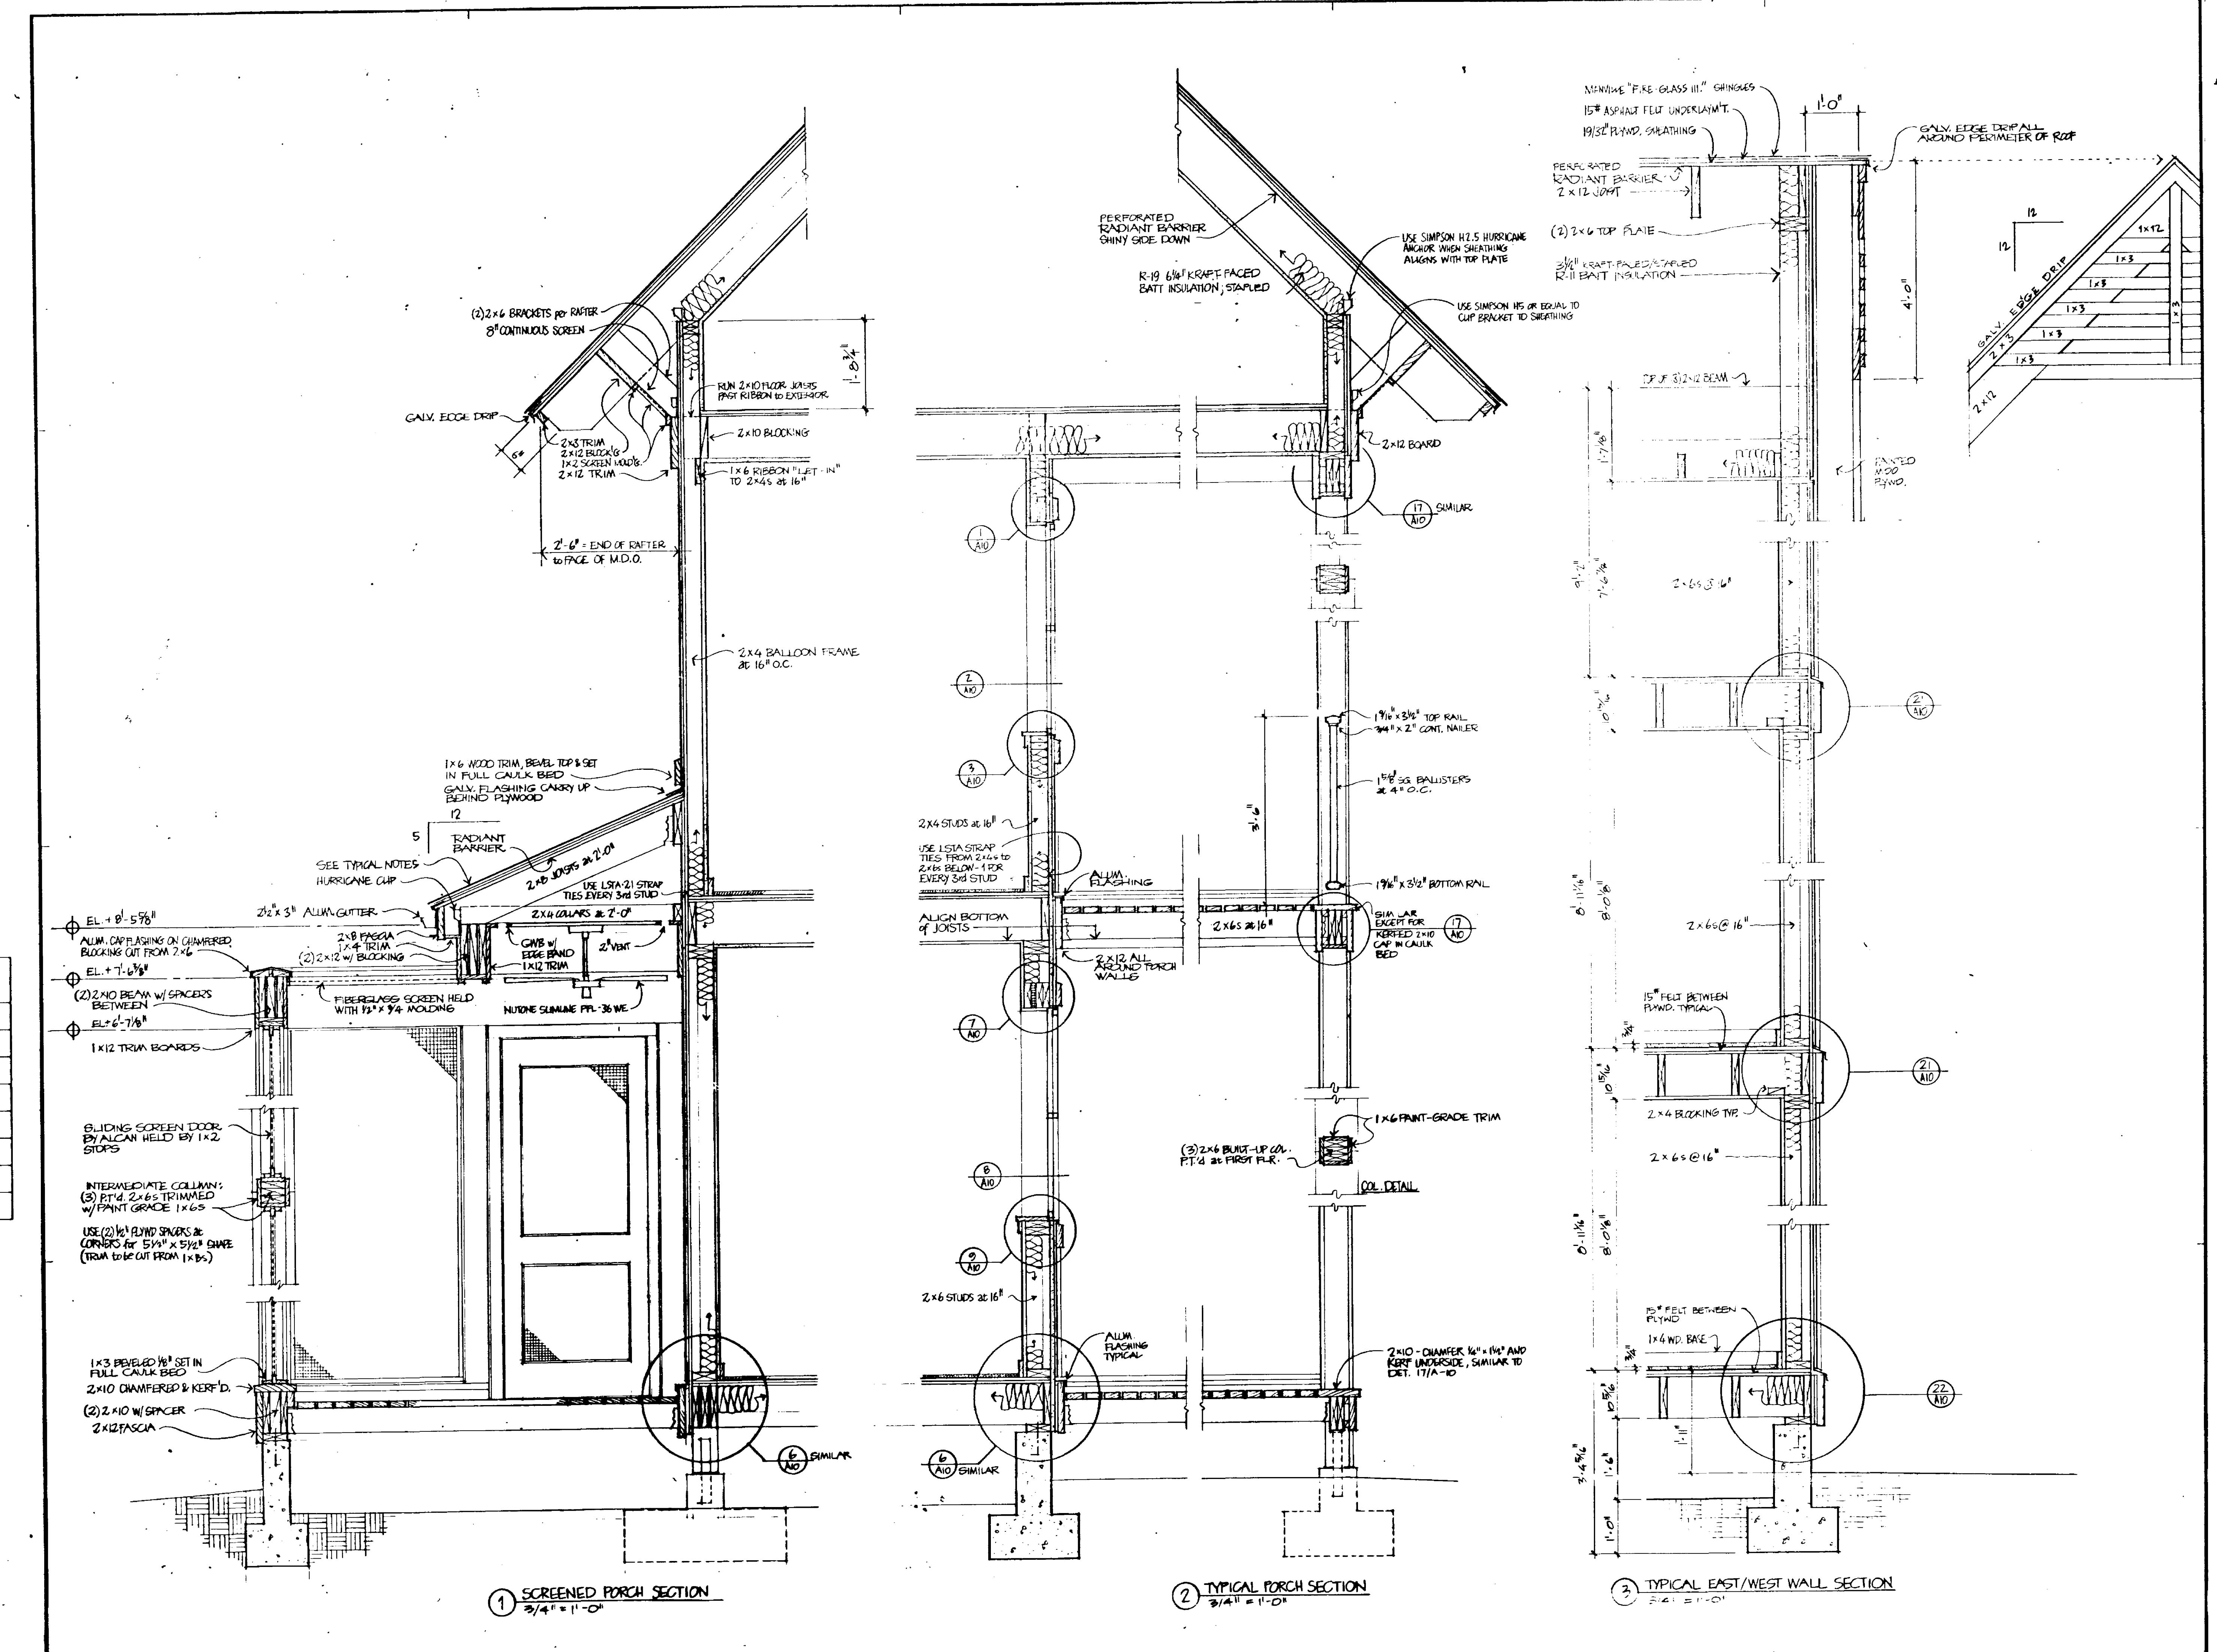ALTERNATE LAUNDRY PLAN

ALTERNATE THIRD FLOOR: 3RD & 4TH BEDROOMS & 2ND BATH

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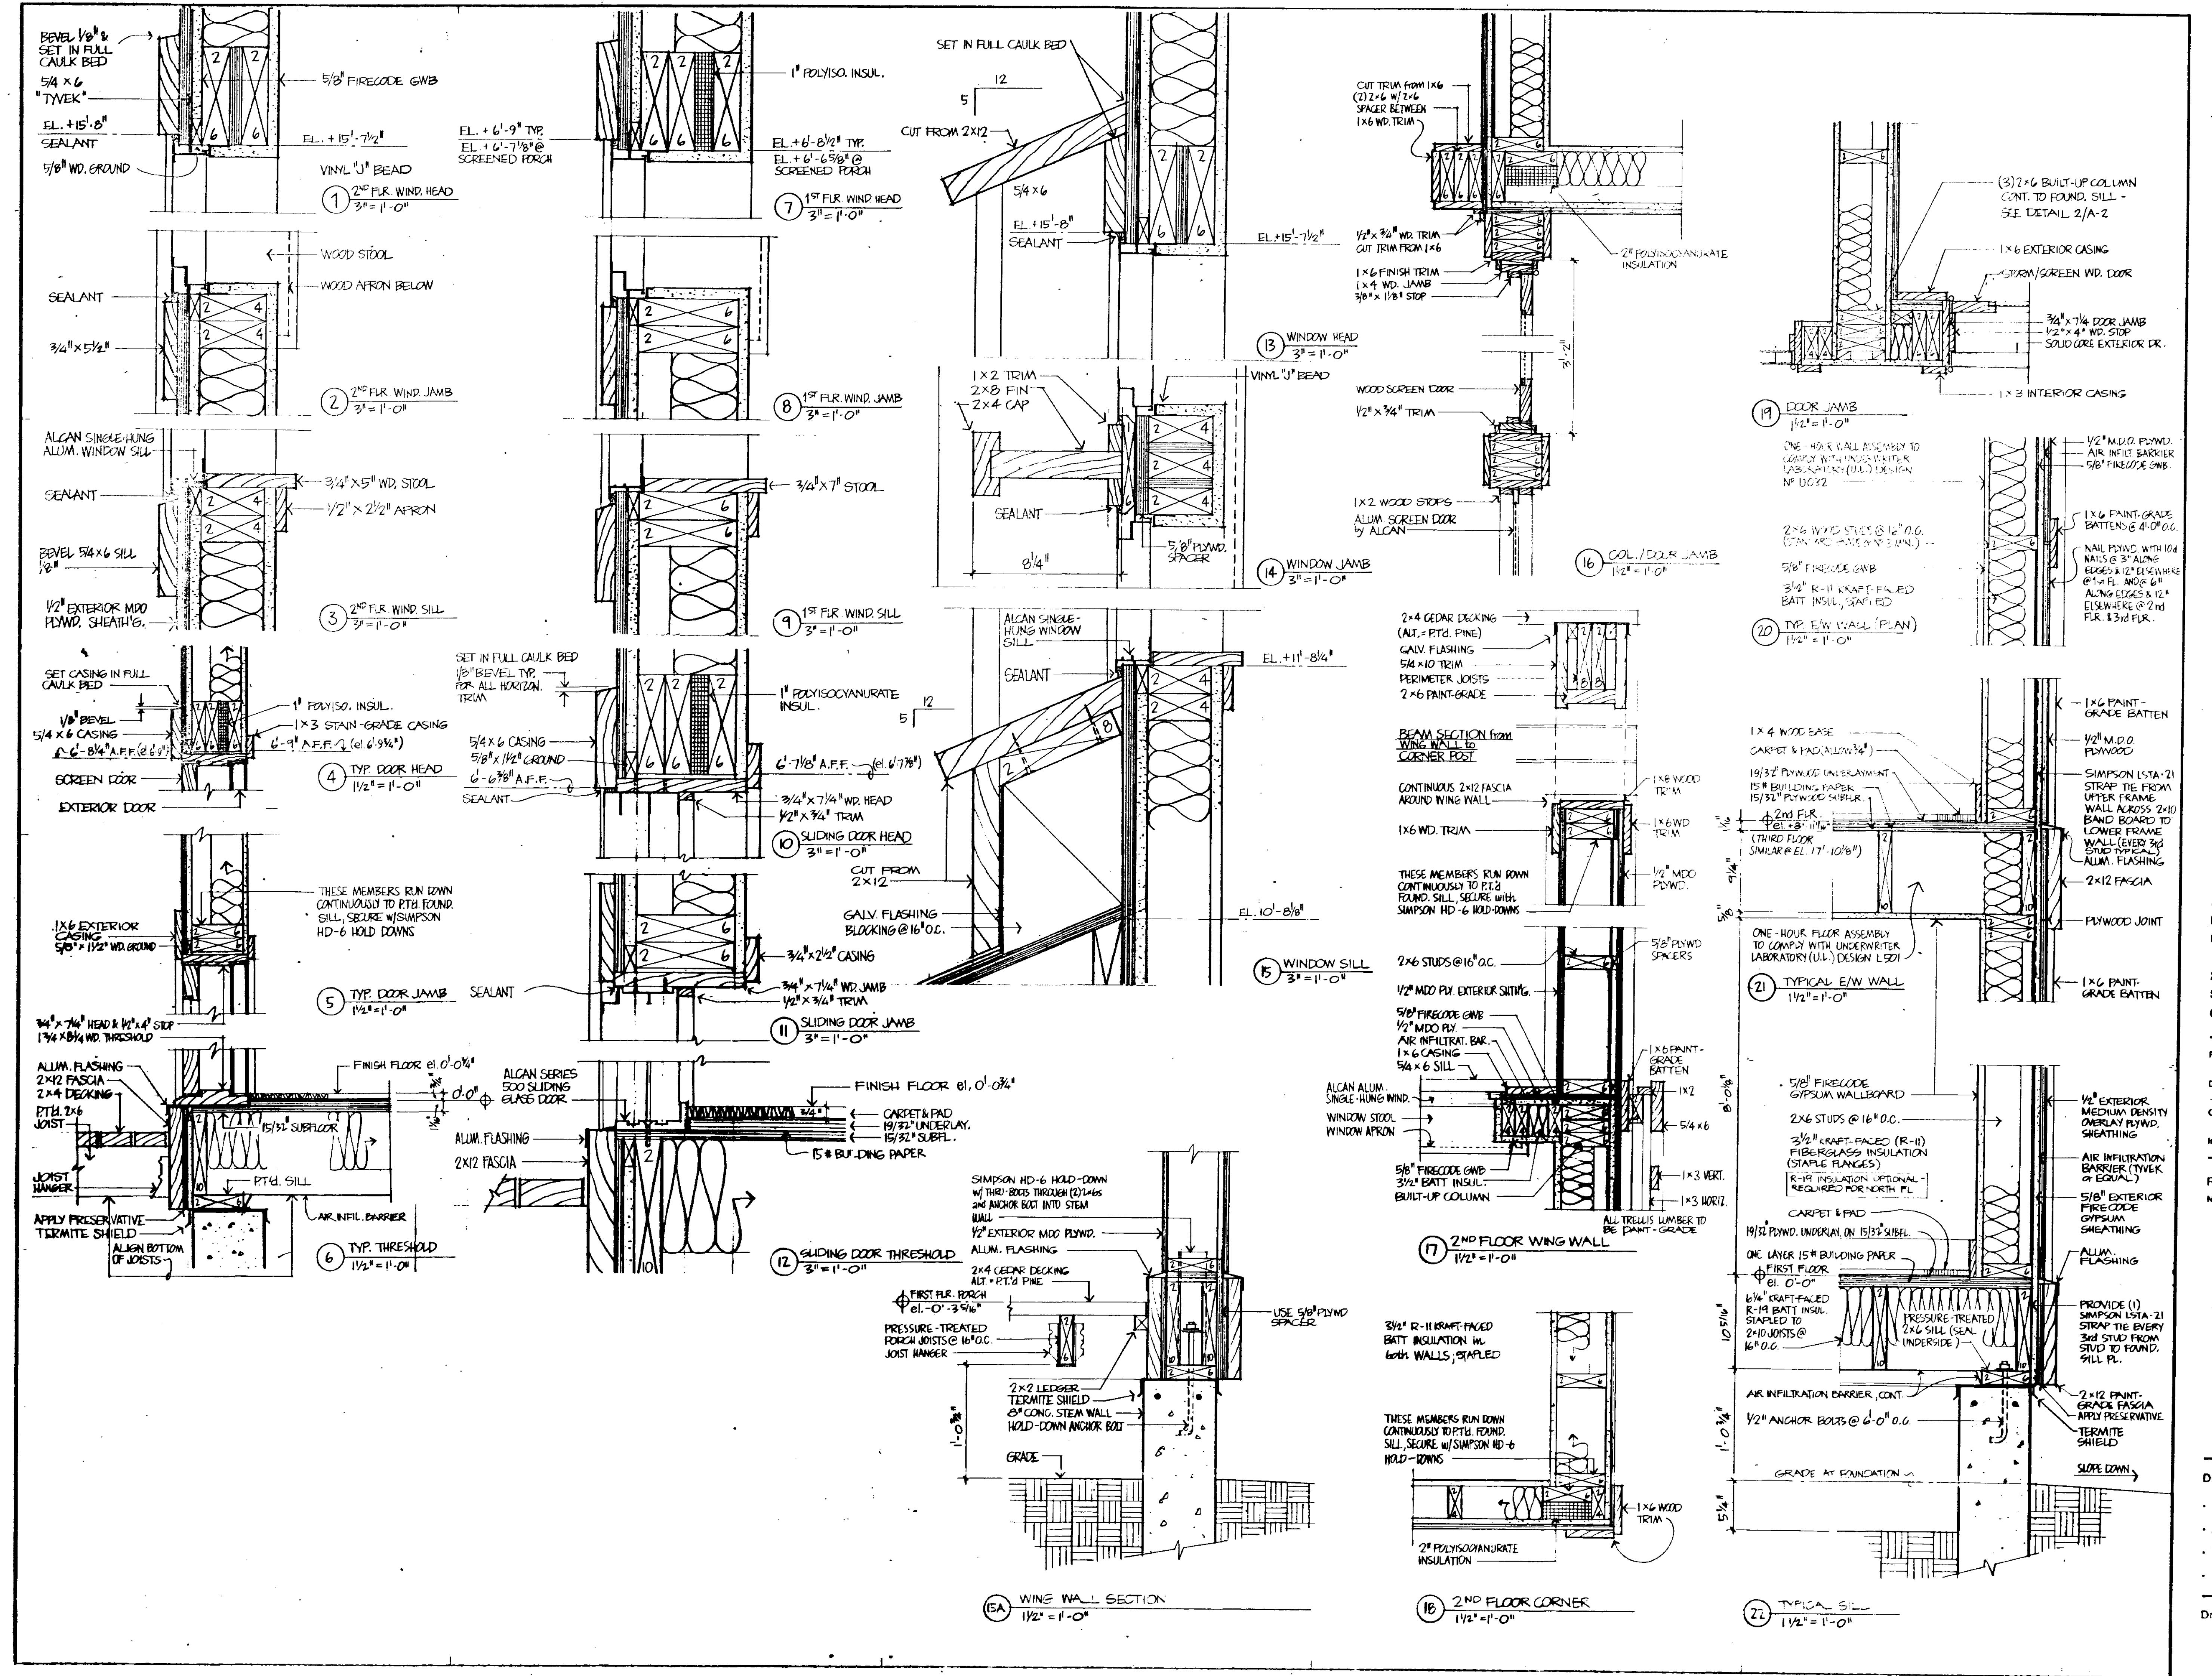
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TYPICAL DETAILS

Drawing Number

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ENERGY EFFICIENT AND AFFORDABLE HOME

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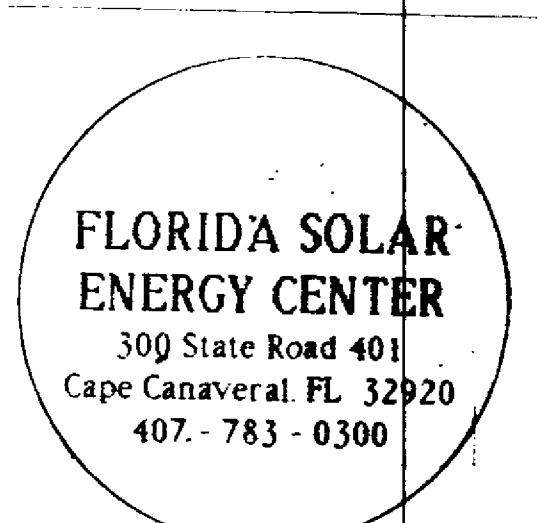
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1 KITCHEN WEST ELEV.

REF.
2' 4" DEEP CAB OVER REF.
2' 0" MIN. DEPTH

GWB SOFFIT & FLUOR. LT.
SIDE MID FLUOR. W/ 2' BAFFLE
ELEC. OUTLETS THRU FULL HOT SPLASH SPLASH UP TO WINDOW STOOL.

POSITION CAB FOR DN CLEARANCE (2' 0")

2 NORTH ELEV.

3' 0" DIA FAN
SINGLE LAMP FLUOR W/ ACRYLIC WRAP DIFFUSER, MID TO SOFFIT FACE

PLUG LAM. FINISH OR HD. WOOD VENEER PLYWOOD W/ CLR. FINISH CABINETS

3 EAST ELEV.

OPEN SHELVES
HOOD
FULL HOT SPLASH
DROP-IN RANGE

4 BATH 1 EAST ELEV.

FLUOR. WALL FIXTURE, TYP.
MIRROR/CABINET, TYP.
C. TILE SOAP & BRUSH HOLDER
PLAS. LAM. FIN. VANITY CAB W/ SET-IN LAV. TYP.

5 NORTH ELEV.

PPD GWB, TYP.
C. TILE ON TILE BACKER BOARD

6 WEST ELEV.

WALL RECESSED CLOSET (ALT.)

7 SOUTH ELEV.

2' 0" CUE FOR ALT. BATH 2

8 MASTER BATH 2 WEST ELEV.

PPD GWB SUPPORT
INCISED MED CAB & MIRROR
TILE ON WALL C. TYP.
KALL. HUNG VANITY W/ SINK TOP OVER WC.
TILE JAMB PATERNAL W/ TILED STEP

9 SOUTH ELEV.

10 EAST ELEV.

11 NORTH ELEV.

12 ALT. POWDER RM. WEST ELEV.

PPD GWB
SIDE SPLASH
PPD NO. BASE

13 EAST ELEV.

14 ALT. BATH 2/A EAST ELEV.

15 SOUTH ELEV.

INTERIOR ELEVATIONS

DOOR SCHEDULE					
LOCATION	TYPE	SIZE	IN	MAT	MIN. HARDWARE
Screen room	1 screen	3'-0"x6'-0"	1-1/2"	wood/fiberglass	closer and lock, glass insert
	2 solid-core flush	3'-0"x6'-0"	1-3/4"	wood	deadbolt, gasket and threshold
	3 sliding glass	6'-0"x6'-0"	"	alum/glass	manual and keyed lock
ALCAN Series 500 / sliding glass door or equal					
Screen porch	4 screen	3'-0"x6'-0"	"	alum/fiberglass	closer and lock
Screen	5 "French"	2'-6"x6'-0"	1-3/4"	wood&glass	deadbolt, gasket and threshold
Screen	6 screen	2'-6"x6'-0"	1-1/2"	wood	closer and lock
Closet	7 h. core flush	2'-6"x6'-0"	1-1/2"	wood	latch set
Upper stor.	8 solid-core flush	2'-6"x6'-0"	1-3/4"	wood	storage lockset & threshold
Lower stor.	9 solid-core flush	2'-0"x2'-9"	1-3/4"	wood	latch set, deadbol & full gasket
Dry	10 solid-core flush	2'-6"x6'-0"	1-3/4"	wood	lockset, gasket and threshold
Dry	11 solid-core flush	2'-6"x6'-0"	1-3/4"	wood	deadbolt, gasket and threshold
Dry	12 screen	2'-6"x6'-0"	1-1/2"	wood	closer and lock
Laundry	13 h. core flush	2'-0"x6'-0"	1-1/2"	wood	latch set
Laundry	14 pair:	2(3'-0"x	"	wood	
	louvered bifold	6'-0")	"	"	
Powder	15 h. core flush	2'-0"x6'-0"	1-1/2"	wood	privacy lock
Landing	16 h. core flush	2'-6"x3'-0"	1-1/2"	wood	flush pull, latch, full gasket
	17 h. core flush	2'-0"x6'-0"	1-1/2"	wood	latch set
	18 louvered bifold	2'-6"x0")	"	wood	
1	19 h. core flush	2'-0"x6'-0"	1-1/2"	wood	privacy lock
Room 1	20 h. core flush	2'-6"x6'-0"	1-1/2"	wood	privacy lock
Room 1	21 pair:	2(2'-6"x	"	wood	
	louvered bifold	6'-0")	"	"	
Screen porch	22 "French"	2'-6"x6'-0"	1-3/4"	wood	deadbolt, gasket and threshold
Room 2	23 h. core flush	2'-6"x6'-0"	1-1/2"	wood	latch set
Room 2	24 pair:	2(2'-6"x	"	wood	
	louvered bifold	6'-0")	"	"	
Screen porch	25 "French"	2'-6"x6'-0"	1-3/4"	wood	deadbolt, gasket and threshold
Bedroom	26 h. core flush	2'-6"x6'-0"	1-1/2"	wood	privacy lock
Bedroom	27 pair:	2(2'-0"x	"	wood	
	louvered bifold	6'-0")	"	"	
Bedroom	28 pair:	2(2'-0"x	"	wood	
	louvered bifold	6'-0")	"	"	
Bedroom	29 pair:	2(2'-0"x	"	wood	
	louvered bifold	6'-0")	"	"	
Bath	30 h. core flush	2'-0"x6'-0"	1-1/2"	wood	ocket w/ privacy lock
Closet	31 h. core flush	2'-0"x6'-0"	1-1/2"	wood	latch set
Bedrm 3	32 h. core flush	2'-0"x6'-0"	1-1/2"	wood	privacy lock
Bedrm 3	33 pair:	2(2'-6"x	"	wood	
	louvered bifold	6'-0")	"	"	
Bedrm 4	34 h. core flush	2'-0"x6'-0"	1-1/2"	wood	privacy lock
Bedrm 4	35 pair:	2(2'-6"x	"	wood	
	louvered bifold	6'-0")	"	"	
Closet	36 h. core flush	2'-0"x6'-0"	1-1/2"	wood	latch set
Attic 2	37 h. core flush	2'-0"x6'-0"	1-1/2"	wood	privacy lock

FINISH SCHEDULE					
ROOM NAME	FLOOR	CEILING	CLG. HGT.	WALLS	BASE
Living Room	carpet	pld. GWB	8'-0"	pld. GWB	wood
Dining Room	carpet	pld. GWB	8'-0"	pld. GWB	wood
Kitchen	sheet vinyl	pld. GWB	8'-0"/7'-2"	pld. GWB	wood
Laundry / D/F Laundry	sheet vinyl	pld. GWB	8'-0"	pld. GWB	wood
Breakfast Room	sheet vinyl	pld. GWB	8'-0"	pld. GWB	wood
Storage Room	sealed conc.	pld. GWB	varies	pld. GWB	none
Storage Room	sealed conc.	pld. GWB	varies	pld. GWB	none
Closet under stair	carpet	pld. GWB	varies	pld. GWB	wood
Entry to 2nd floor	VCT on phywd.	-	varies	pld. GWB	wood
Storage at landing	pld. phywd.	pld. GWB	varies	pld. GWB	wood
2nd floor hall	carpet	pld. GWB	8'-0"	pld. GWB	none
Bedroom 1	carpet	pld. GWB	8'-0"	pld. GWB	wood
Bedroom 2	carpet	pld. GWB	8'-0"	pld. GWB	wood
Bath 1	car. tile	pld. GWB	8'-0"	pld. GWB/c. tile	car. tile
2/3 closet	phywd.	pld. GWB	7'-0"	pld. GWB	none
Linens closet	carpet	pld. GWB	7'-0"	pld. GWB	wood
Entry to 3rd floor	wood/VCT	pld. GWB	varies	pld. GWB	wood
Bed & study	carpet	pld. GWB	7'-6-3/4"	pld. GWB	wood
Study closet	carpet	pld. GWB	7'-6-3/4"	pld. GWB	wood
Bedroom 3	carpet	pld. GWB	7'-6-3/4"	pld. GWB	wood
Bedroom 4	carpet	pld. GWB	7'-6-3/4"	pld. GWB	wood
Baths	carpet	pld. GWB	7'-6-3/4"	pld. GWB	wood
Bath 2	car. tile	pld. GWB	7'-6-3/4"	pld. GWB/c. tile	car. tile
1/2 bathroom 3	carpet	pld. GWB	7'-6-3/4"	pld. GWB	wood
1/2 bathroom 4	carpet	pld. GWB	7'-6-3/4"	pld. GWB	wood
Baths	carpet	pld. GWB	7'-6-3/4"	pld. GWB	wood
Bath 2	car. tile	pld. GWB	7'-6-3/4"	pld. GWB/c. tile	car. tile

WINDOW SCHEDULE							
WHOLE HUNG WINDOWS OR EQUAL							
DN	MARKS				SIZE W x H		
DNm	1	2	3	4	2'-8" x 4'-0"		
	5				2'-8" x 4'-0"		
	6	7			2'-2 1/2" x 3'-8 1/4"		
	8				2'-0" x 4'-0"		
	9				2'-0" x 4'-0"		
1	10	11	12	13	2'-0" x 4'-0"		
	15				2'-0" x 4'-0"		
	16	17	18		2'-0" x 4'-0"		
2	19	20	21	22	2'-0" x 4'-0"		
	24	25			2'-0" x 4'-0"		
oth	26	27			2'-0" x 4'-0"		
ressing	28	29			2'-0" x 4'-0"		
bedroom	30	31	32	33	2'-0" x 4'-0"		
DNm 3	24	25	26	27	2'-0" x 4'-0"		
2A	28	29			2'-0" x 4'-0"		
DNm 4	30	31	32	33	2'-0" x 4'-0"		

Drawing Title:

**INTERIOR ELEV.
SCHEDULES**

Drawing Number

$$A = 11$$

**ENERGY EFFICIENT
AND
AFFORDABLE HOME**

900 S. BASE

PHASE I EXPANSION: MASTER BEDROOM SUITE

ALTERNATE LAUNDRY PLAN

ALTERNATE THIRD FLOOR: 3RD & 4TH

BEDROOMS & 2ND BATH

These drawings and specifications are intended to indicate the approximate location of the piping system. They are not to be interpreted as being exact or complete. Any piping installed must be installed in accordance with the applicable codes and regulations of the local authority having jurisdiction.

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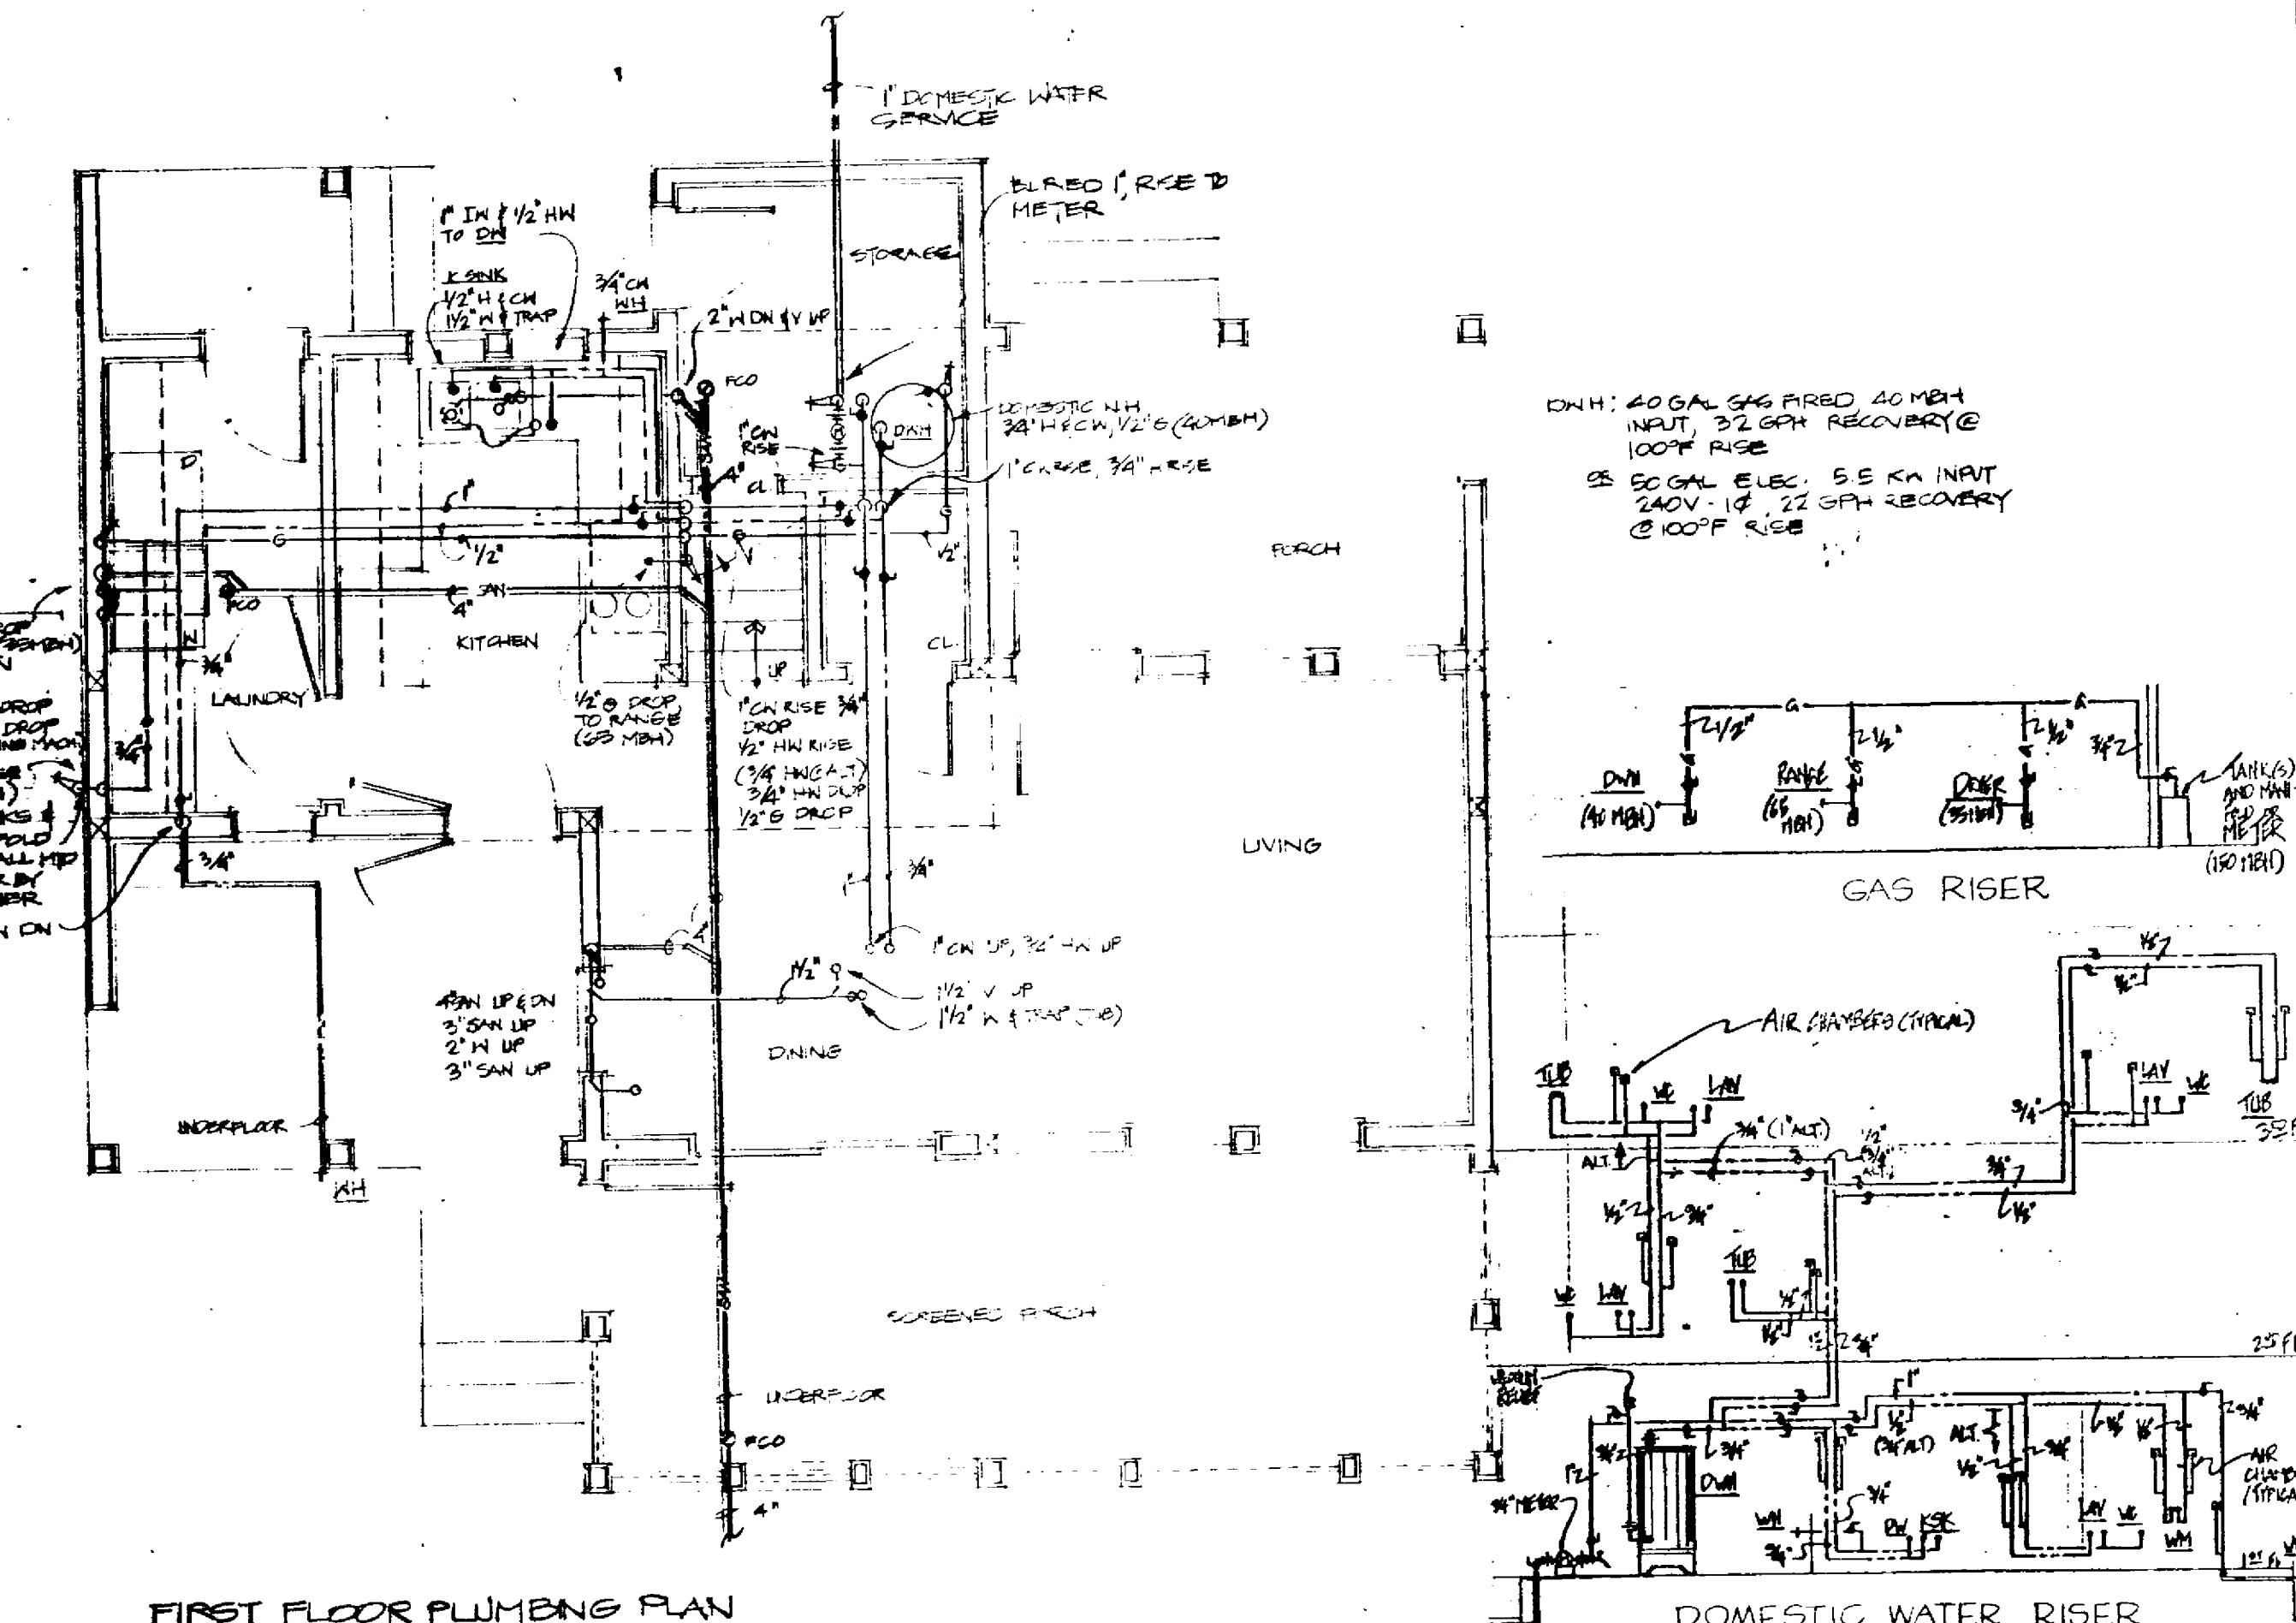
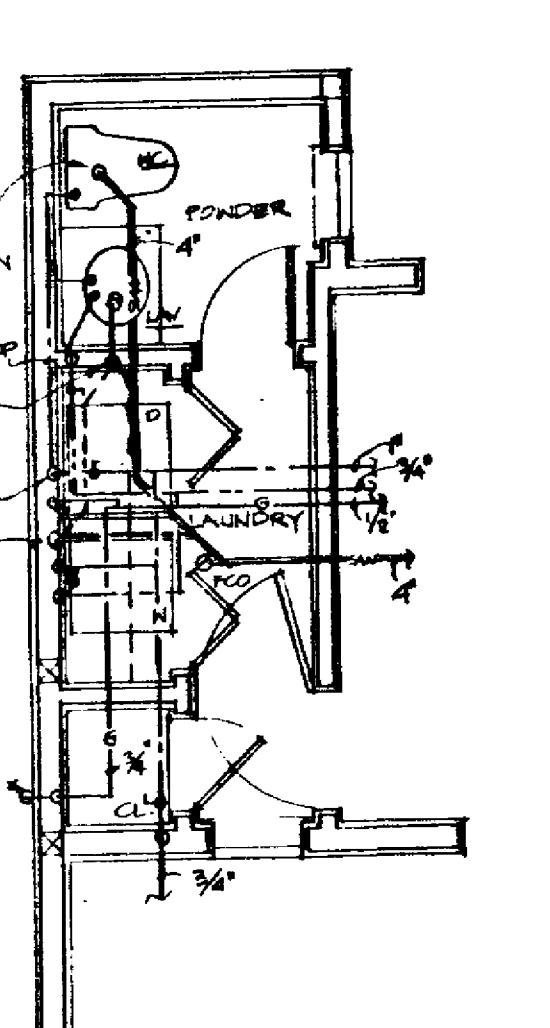
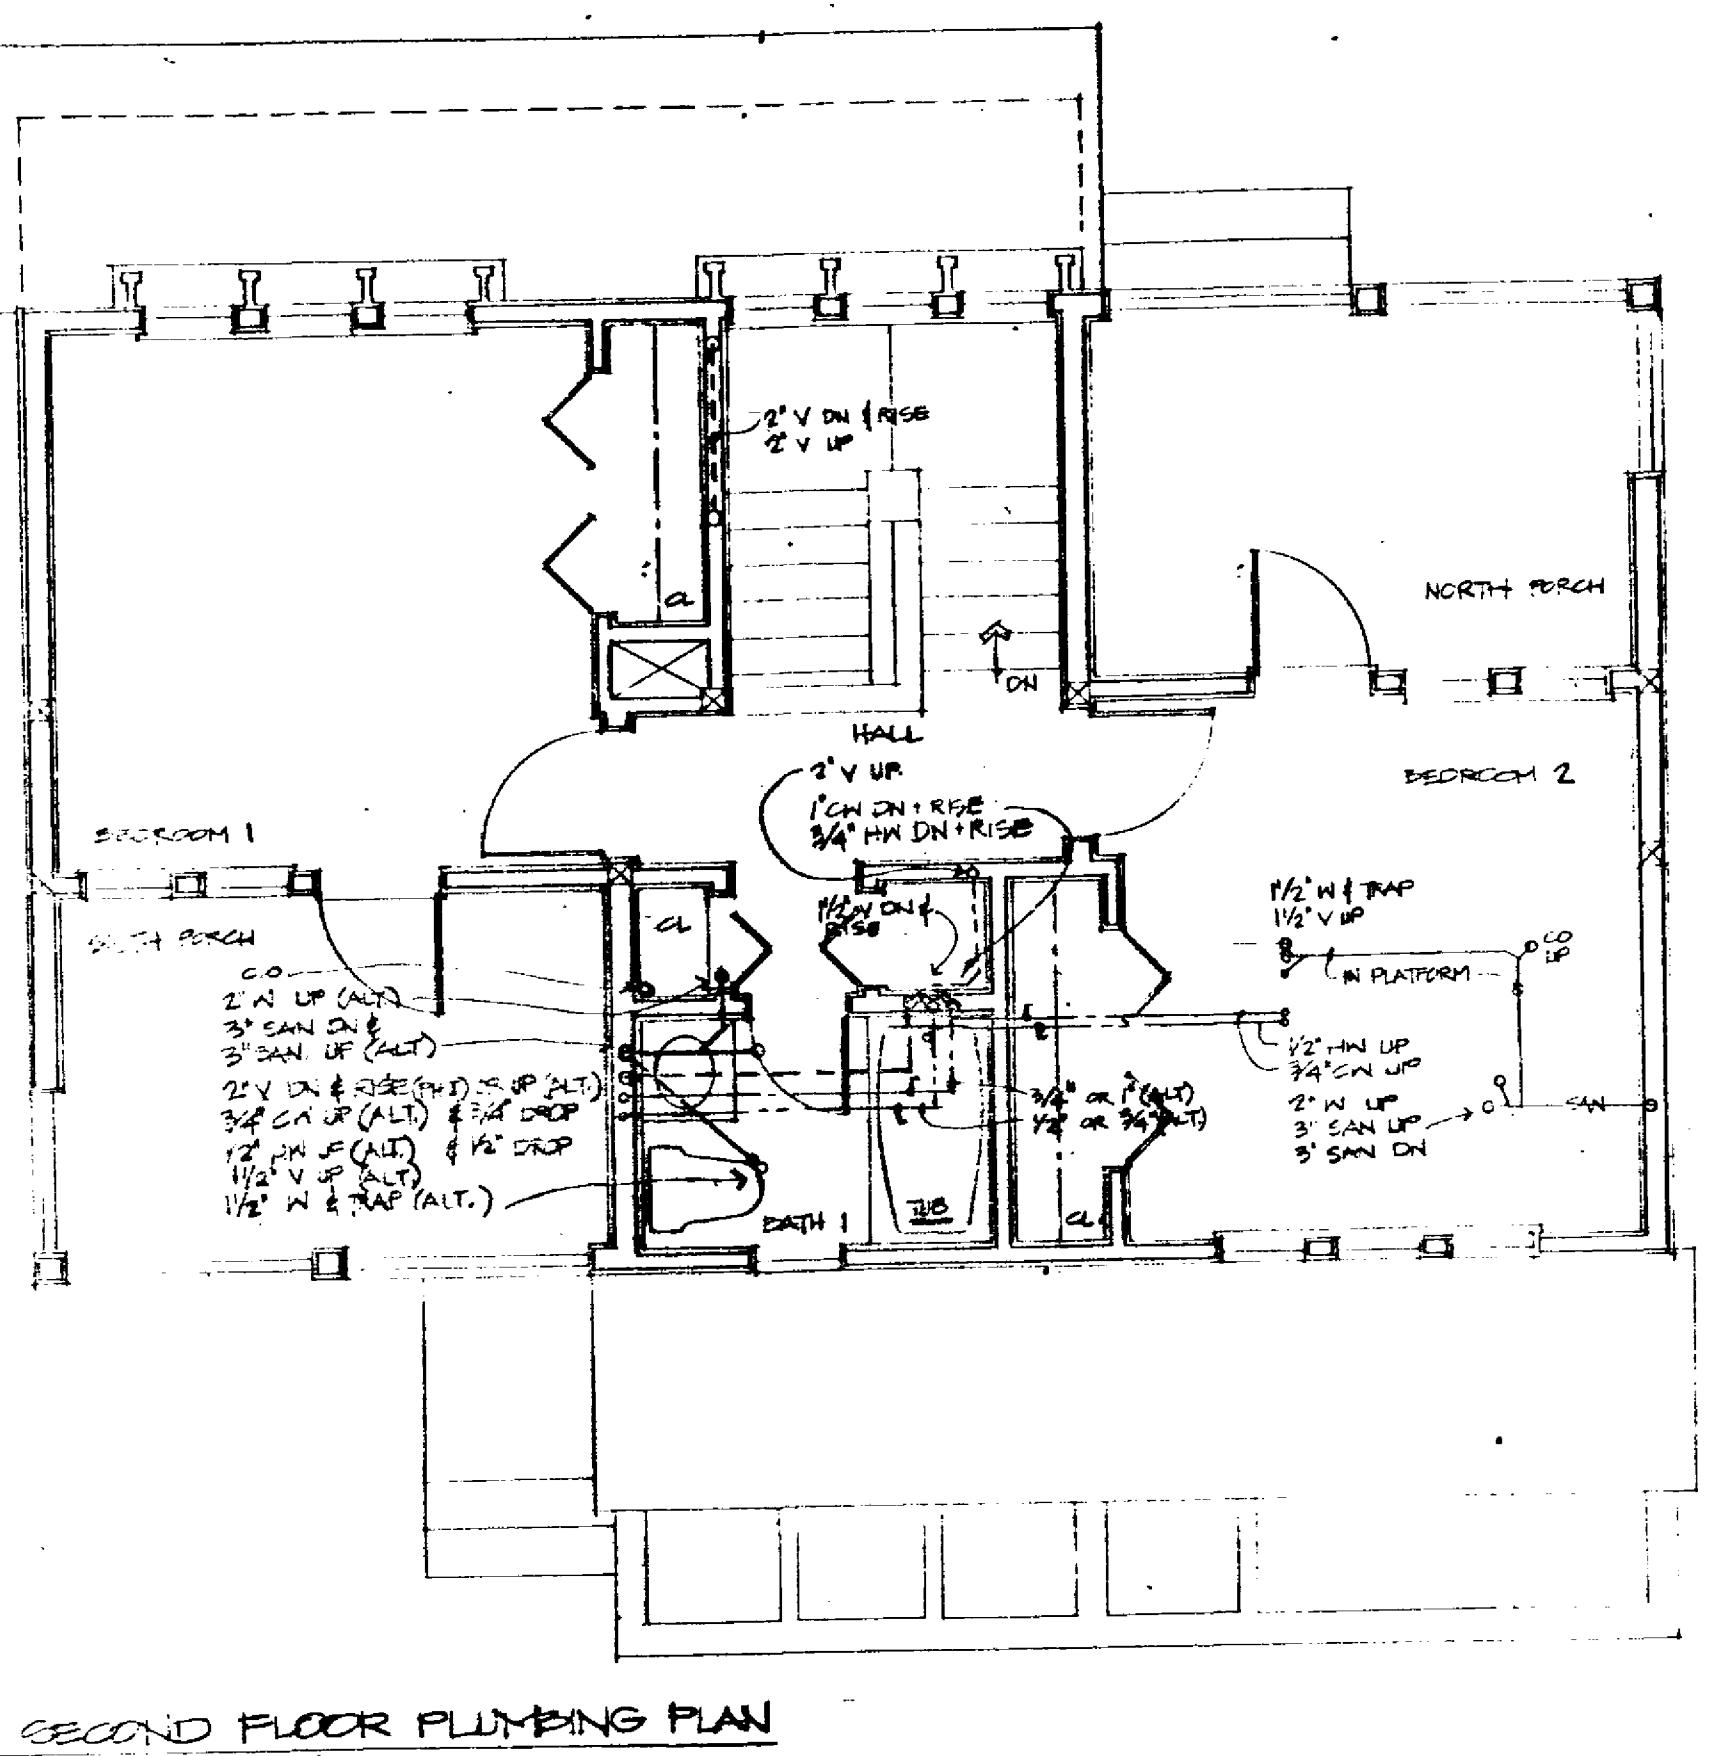
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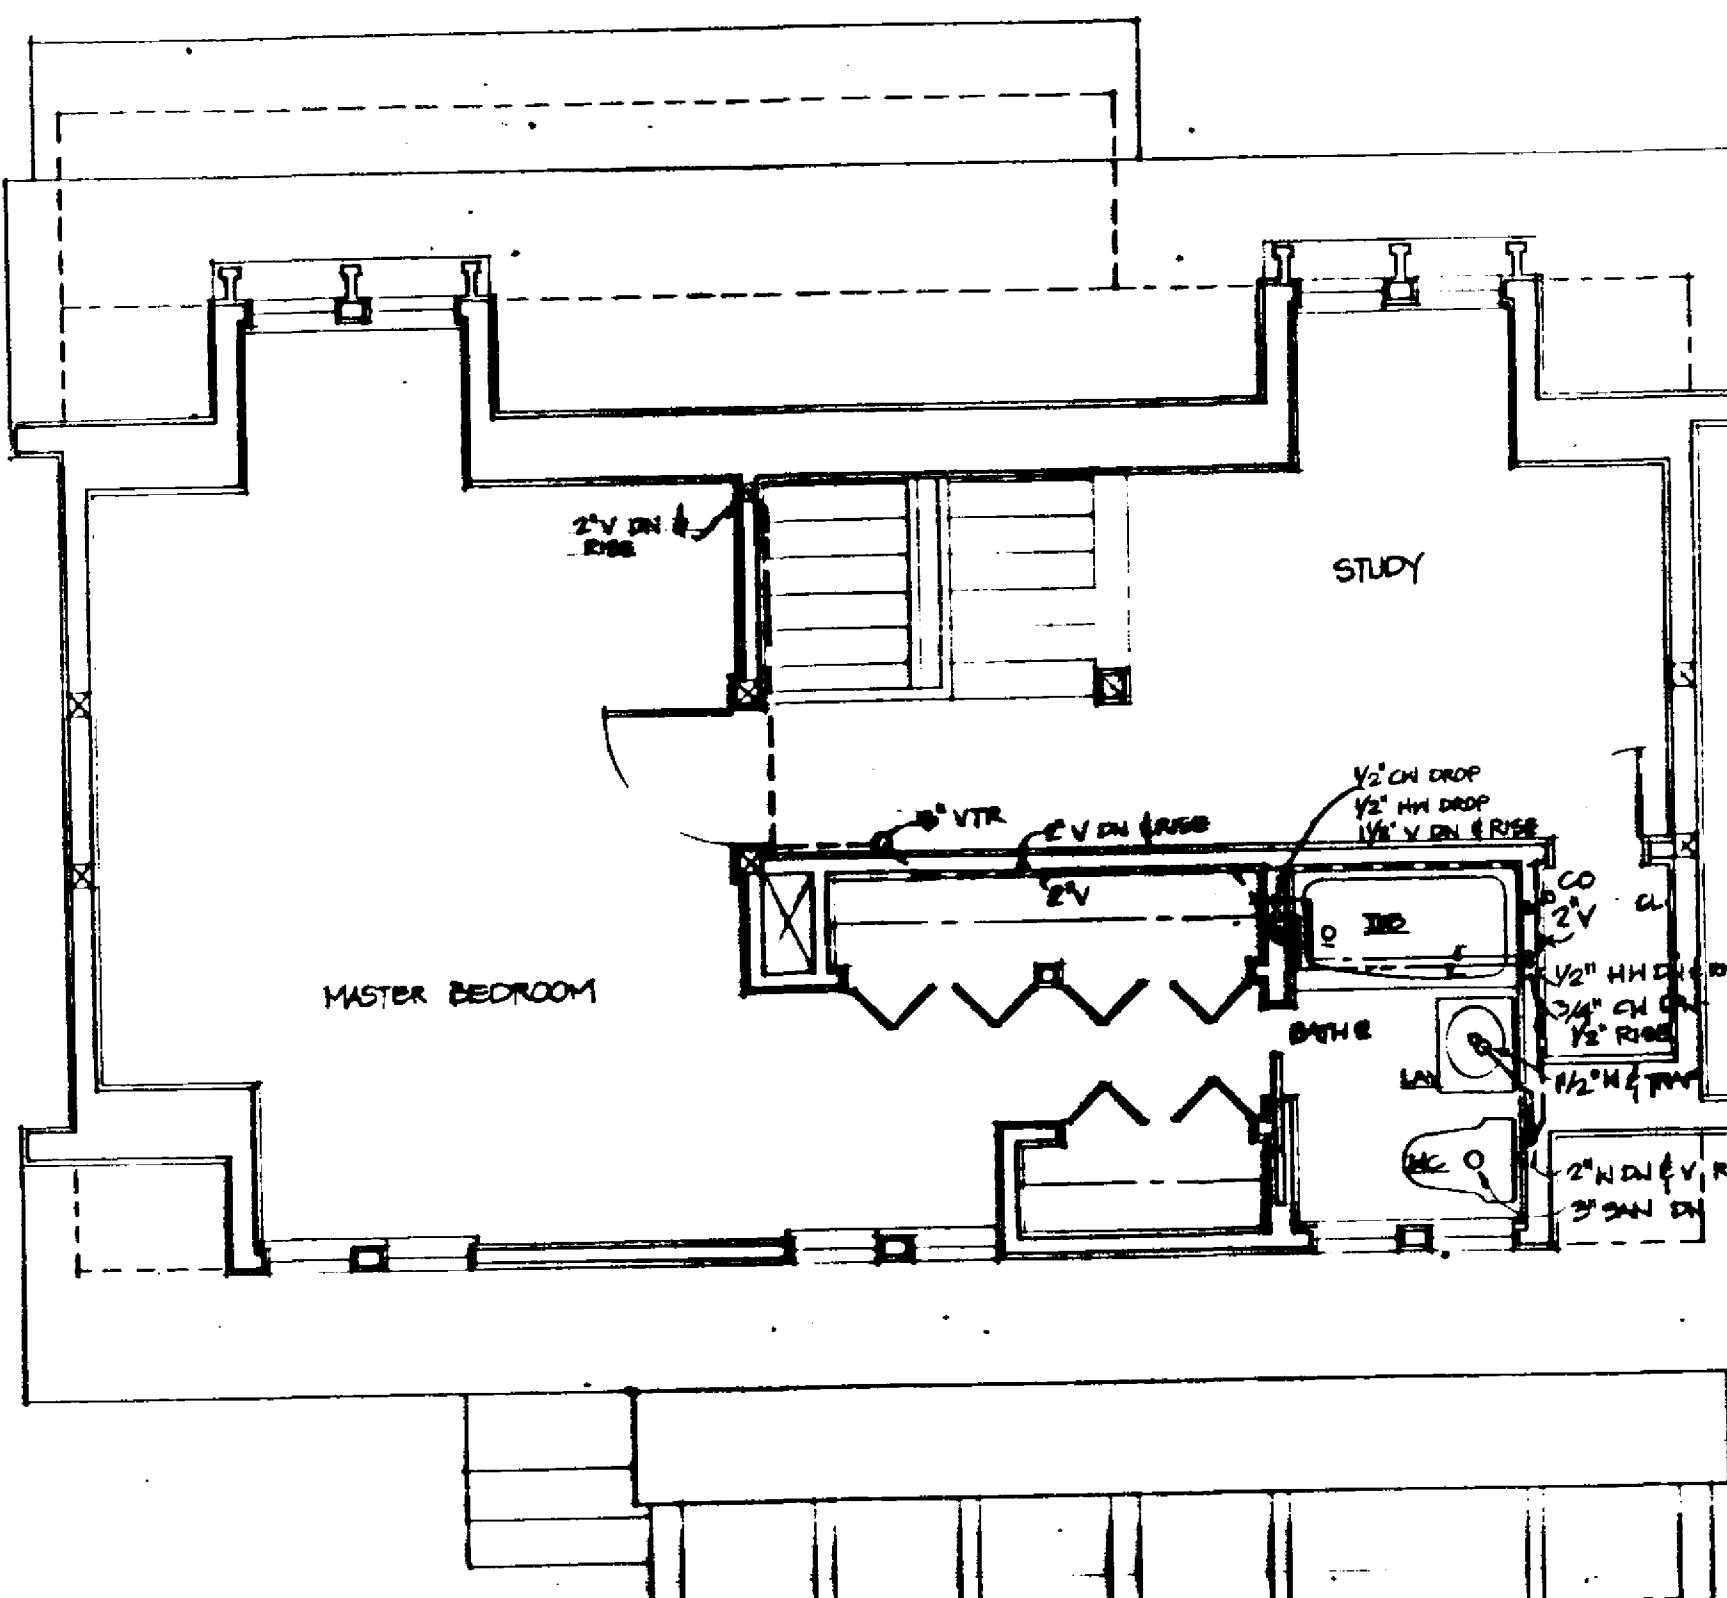
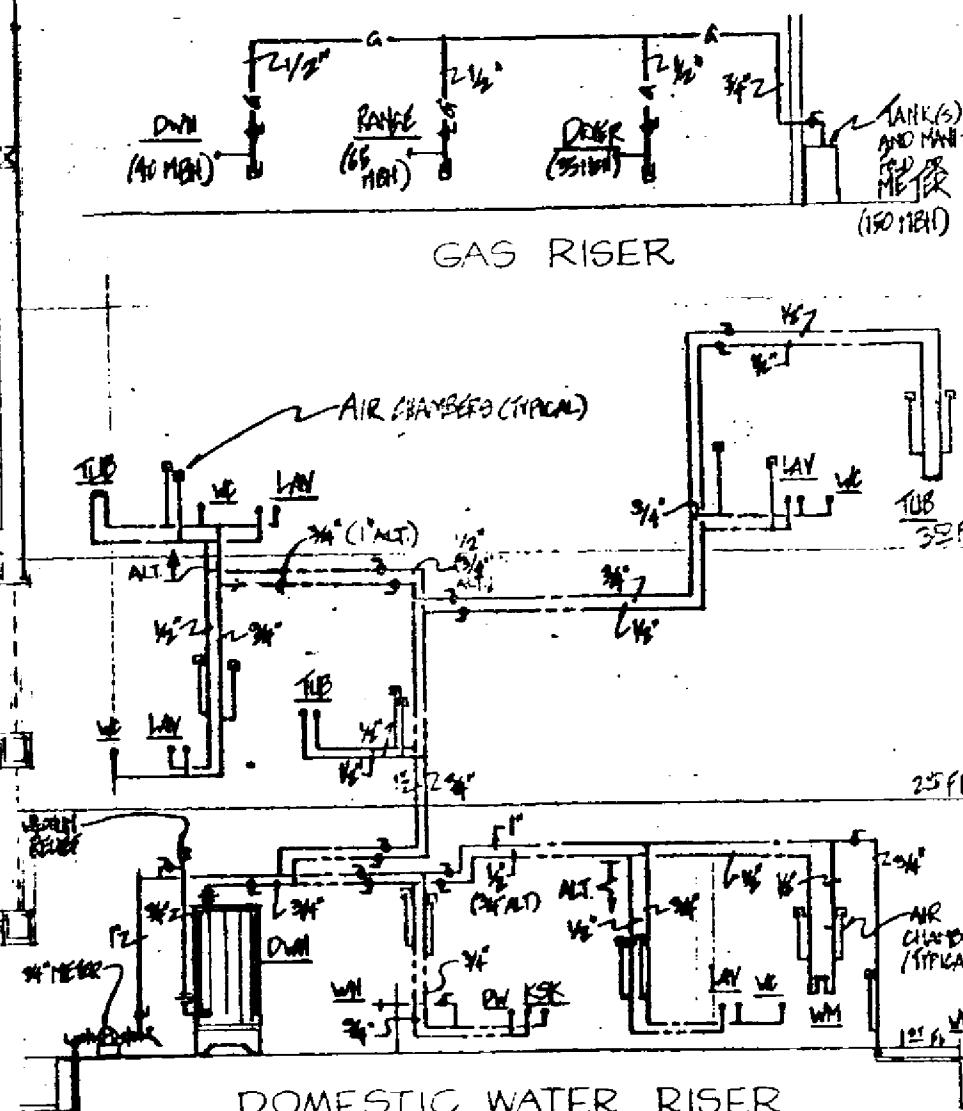
300 State Road 401

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407-783-0300





DN: 40 GAL GAS FIRED 40 MPH
INPUT: 0.2 GPM RISE
100F RISE
DS: 50 GAL ELEC. 5.5 KW INPUT
240V 10.22 GPM RISE
0.300F RISE



TAG ITEM	PLUMBING FIXTURE CONNECTION SCHEDULE		REMARKS	
	CONNECTIONS	ITEM		
WC	3"	2"	1/2"	Tank-type, floor outlet (1.5gal)
LAV	1-1/2"	1-1/2"	1/2"	
TUB	1-1/2"	1-1/2"	1/2"	w/ shower & shower (50-1/4" wide)
KSK	1-1/2"	1-1/2"	1/2"	w/ faucet
WM	2"	1/2"	1/2"	w/ laundry shore
DW	2"	2"	2"	on all H.D.P.
DW	1"	1"	1"	w/ direct waste
WH	3/4"	3/4"	-	w/ shower fixture

ITEM	MATERIAL	FABRICATION	
		BURIED AND ABOVE FLOOR	TYPE I SCHEDULE 40 PVC DWV
SANITARY, WASTE AND VENT PIPE AND DRAINAGE PATTERN FITTINGS	Type I Schedule 40 PVC DWV	Soldered or solvent joints with threaded adapters to other materials	
Above floor fixture traps	Hard drawn type DWV copper and vent thru roof with wrought copper or brass or aluminum pattern fittings	Soldered or solvent joints, cleaned and rinsed, recessed with no lead solder and non-expansive flux	
Domestic hot & cold water distribution piping	Hard drawn type L. copper tubing w/ lead brass or aluminum pattern fittings	Soldered or solvent joints, cleaned and rinsed, recessed with no lead solder and non-expansive flux	
Pipe insulation	1/2" thick fiberglass cloth w/ mineral wool barrier, except chrome plated DWV	1/2" thick mineral wool	
Gas system piping	CO2		
Water system piping	CO2		
NOTE: All fixtures and piping are standard code of the Southern Building Conference			

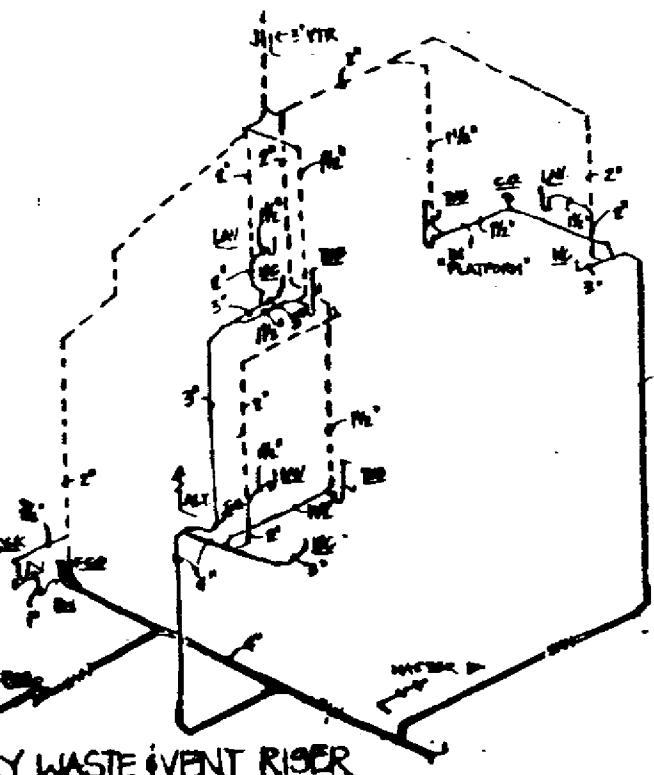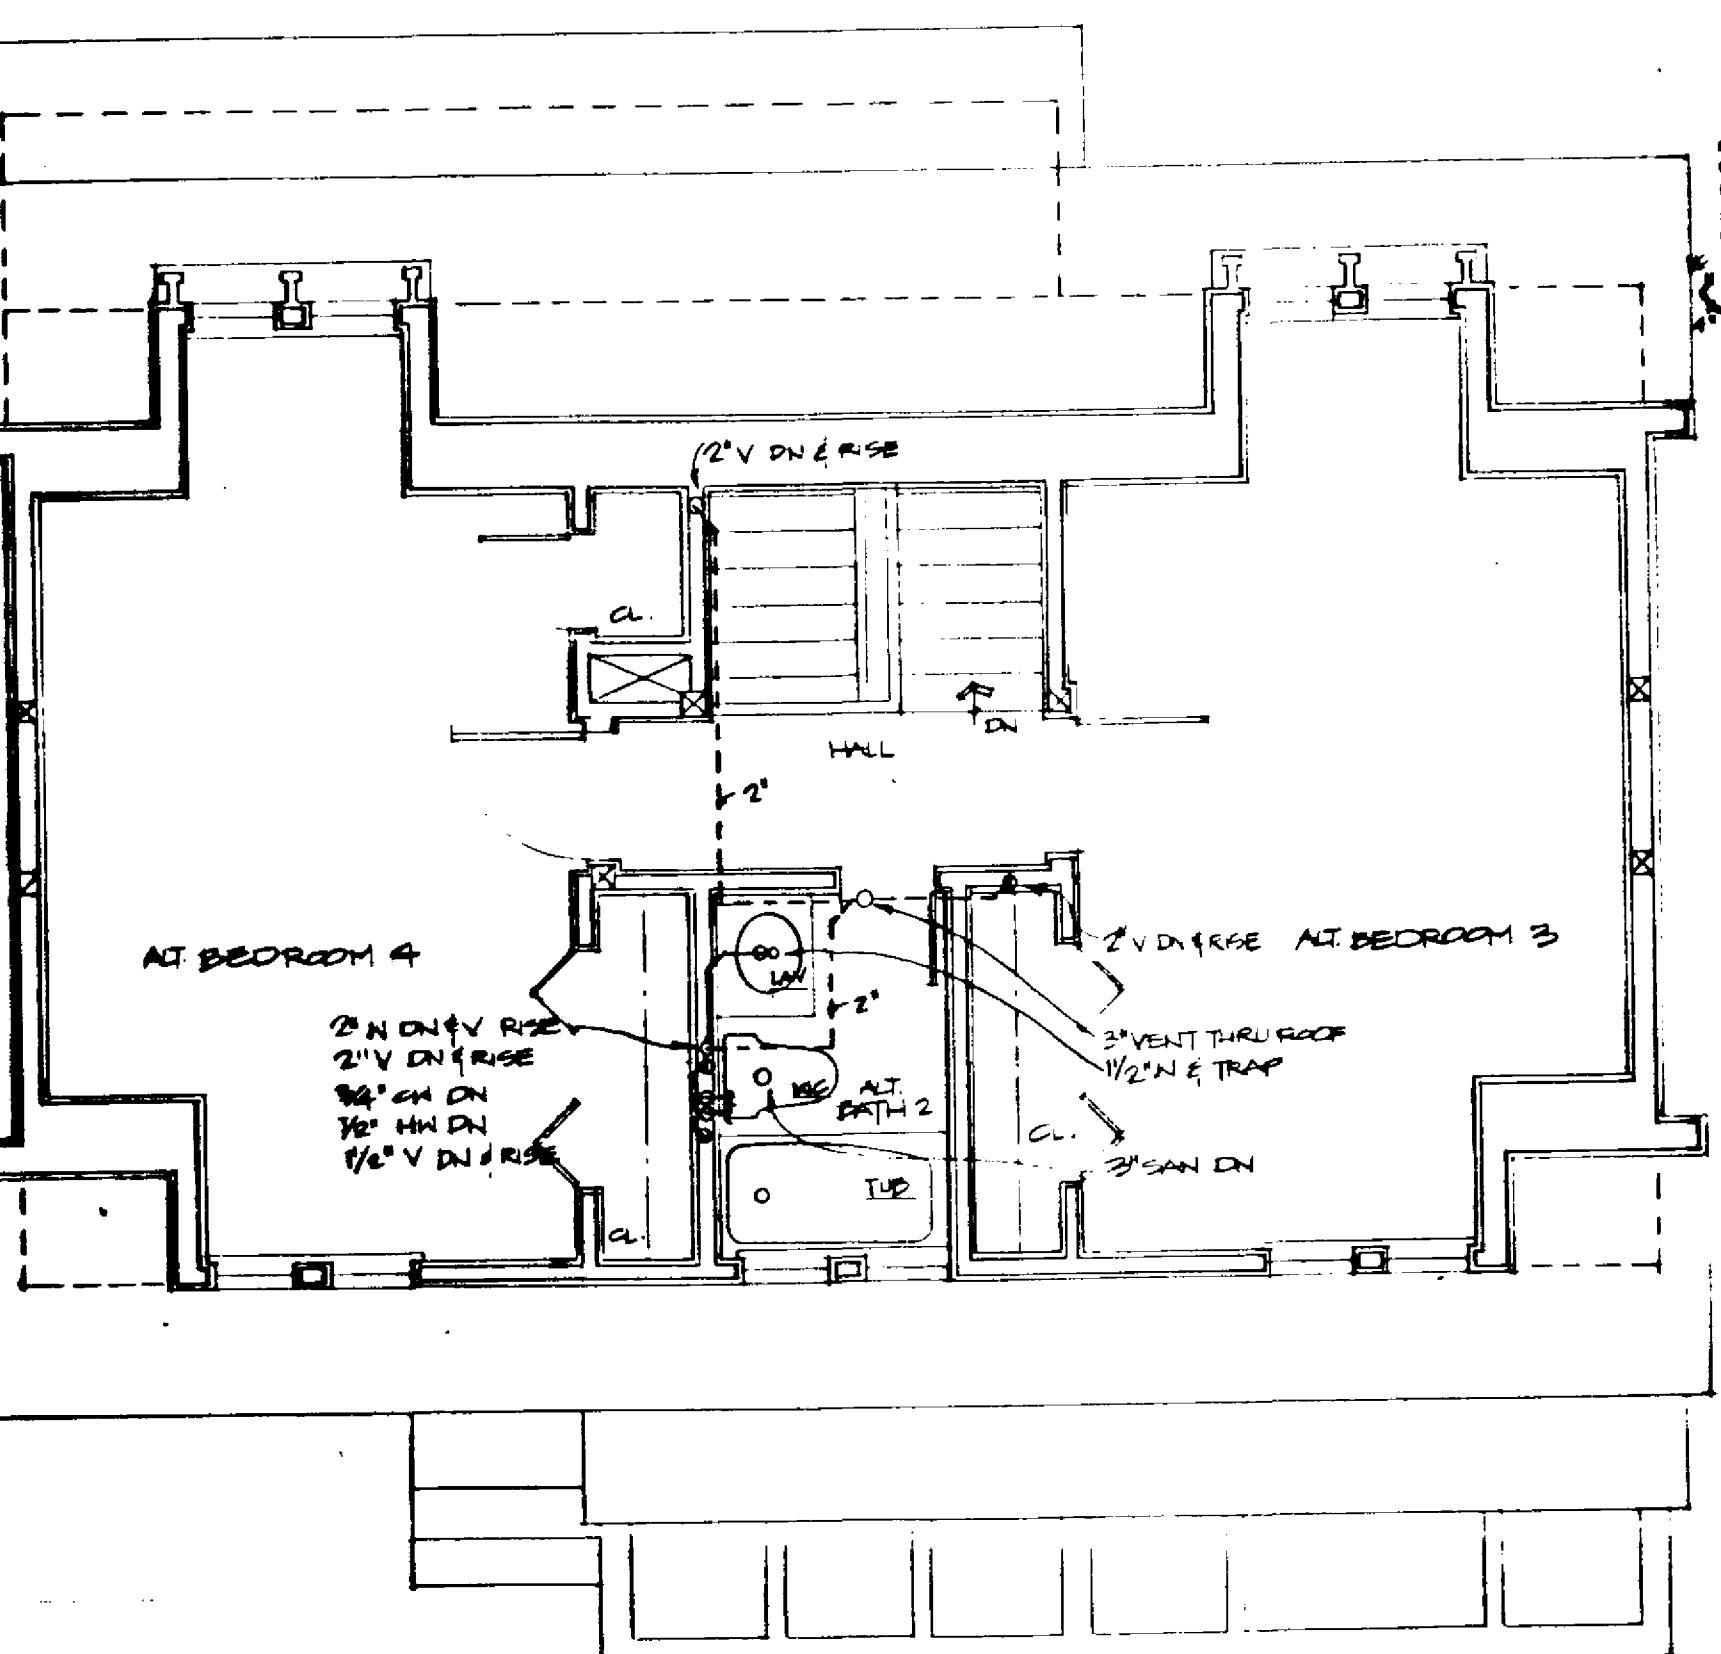

PLUMBING SYMBOLS		
—	Double line indicates below floor	
SAN	S.W. Sanitary or Waste	
V	V Vent	
CW	Cold water	
HW	Hot water	
G	Gas	
UP	Pipe rises up	
DN	Pipe drops down	
W&T	Waste and trap	
B	Ball valve	
FCO	Floor cleanout	
CD	Clamp	
—	Valve in vertical	
MSH	1000 BTU's per hour	
—	Gas cock	

PLUMBING PLANS

Drawing Number:

P-1

ENERGY EFFICIENT AND AFFORDABLE HOME

900 S. F. BASE


PHASE I EXPANSION, MASTER BEDROOM SUITE

ALTERNATE LAUNDRY PLAN
ALTERNATE THRD FLOOR: 3RD & 4TH BEDROOMS & 2ND BATH

This drawing shows the electrical system for the project. It includes the main service entrance, distribution panels, branch circuit wiring, and various electrical fixtures and equipment. The drawing is intended for use only by the licensed electrician and shall be used in accordance with the National Electrical Code and local codes.

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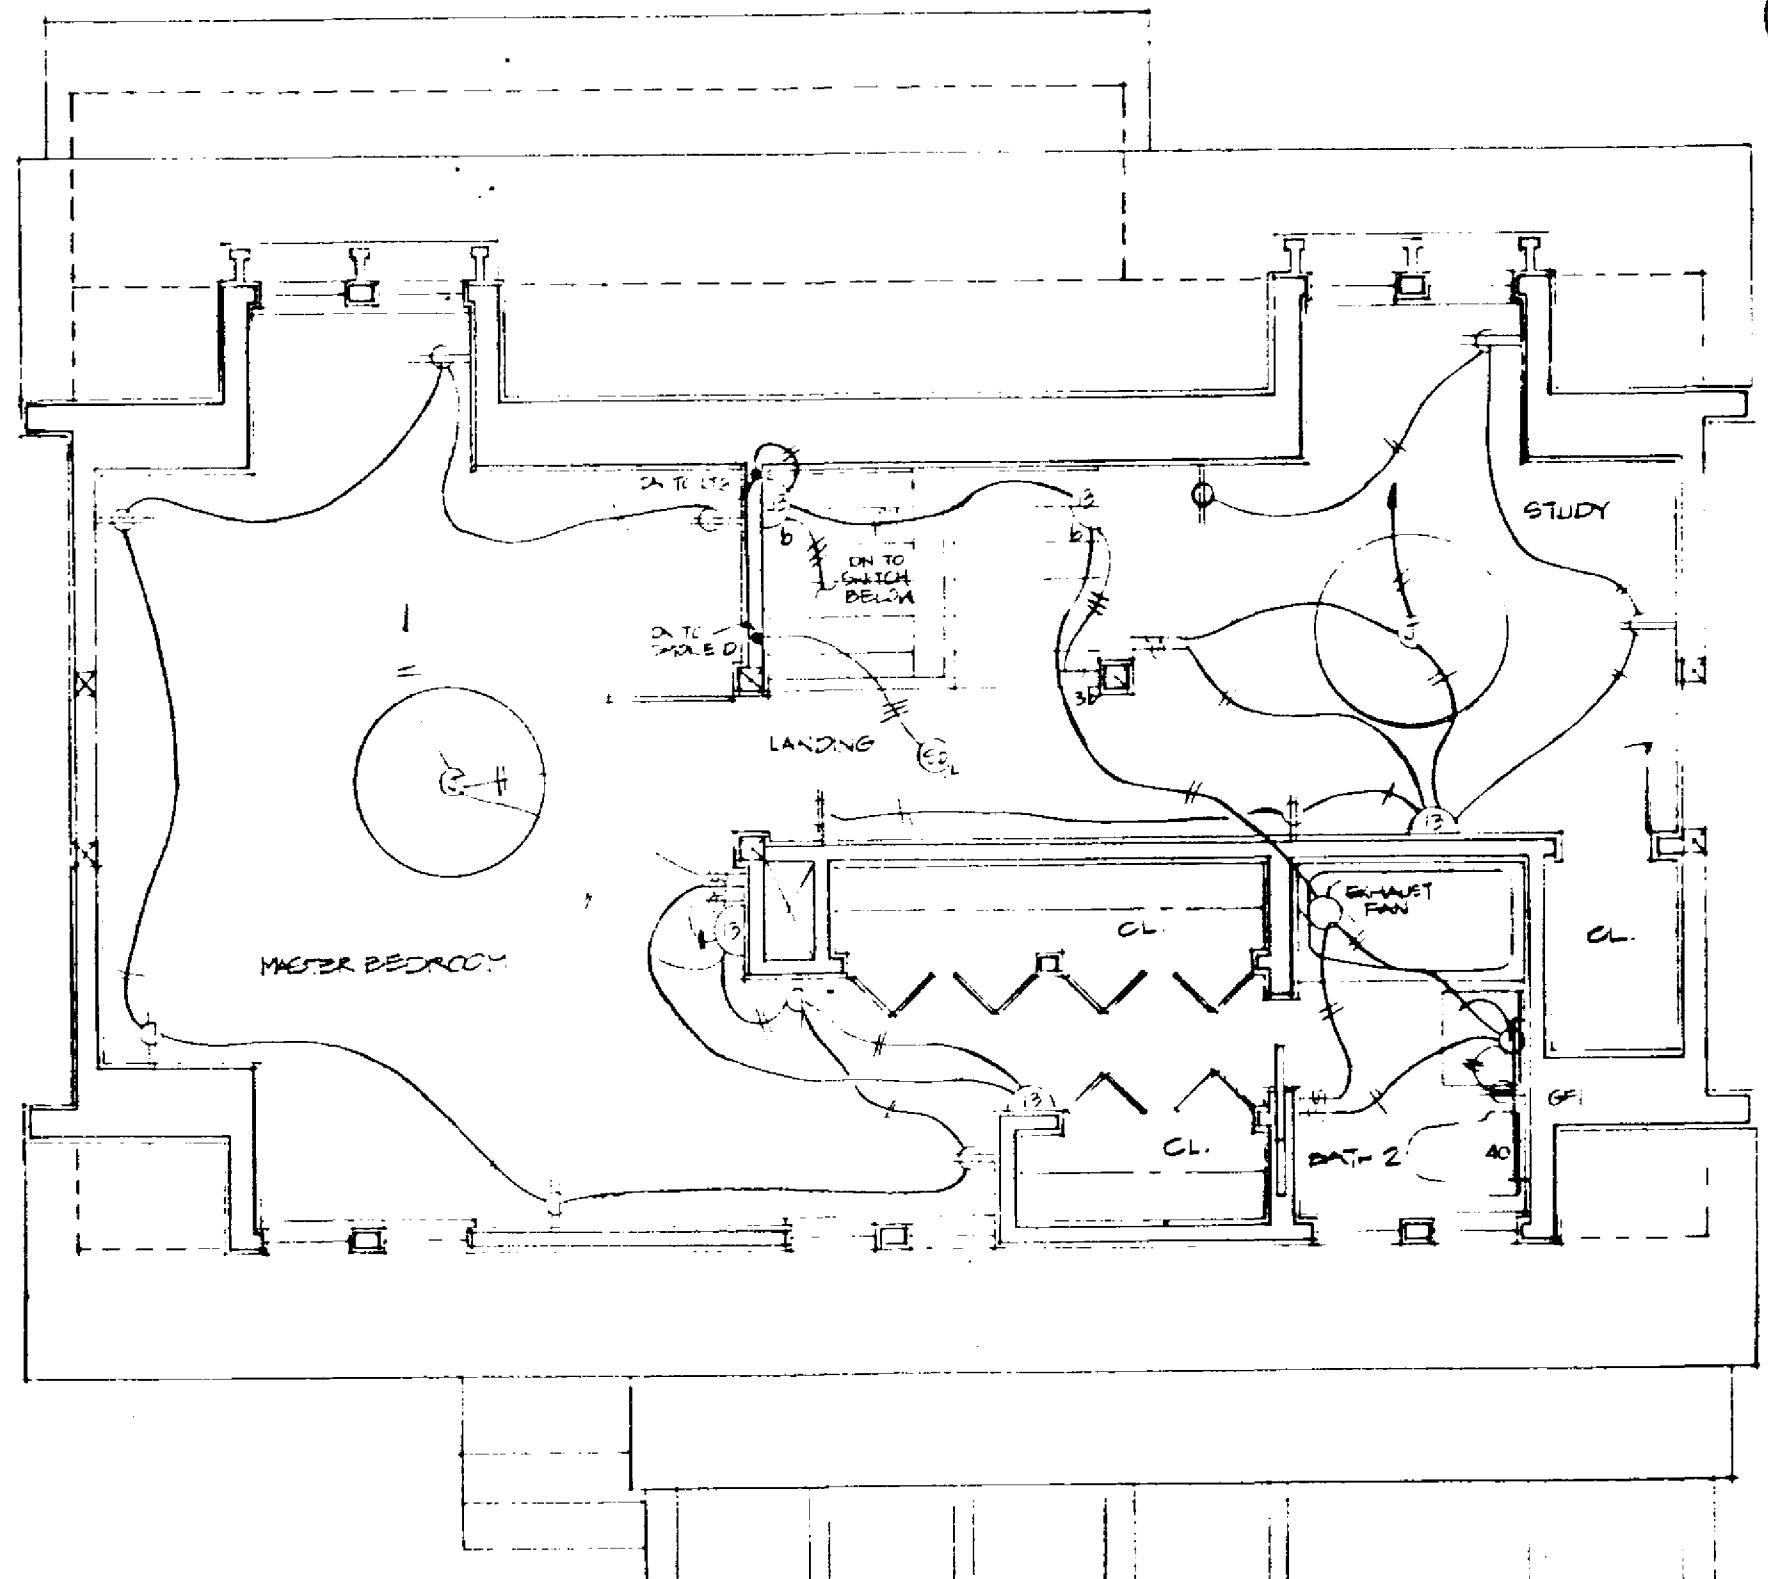
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SECOND FLOOR ELEC PLAN

ELECTRICAL NOTES

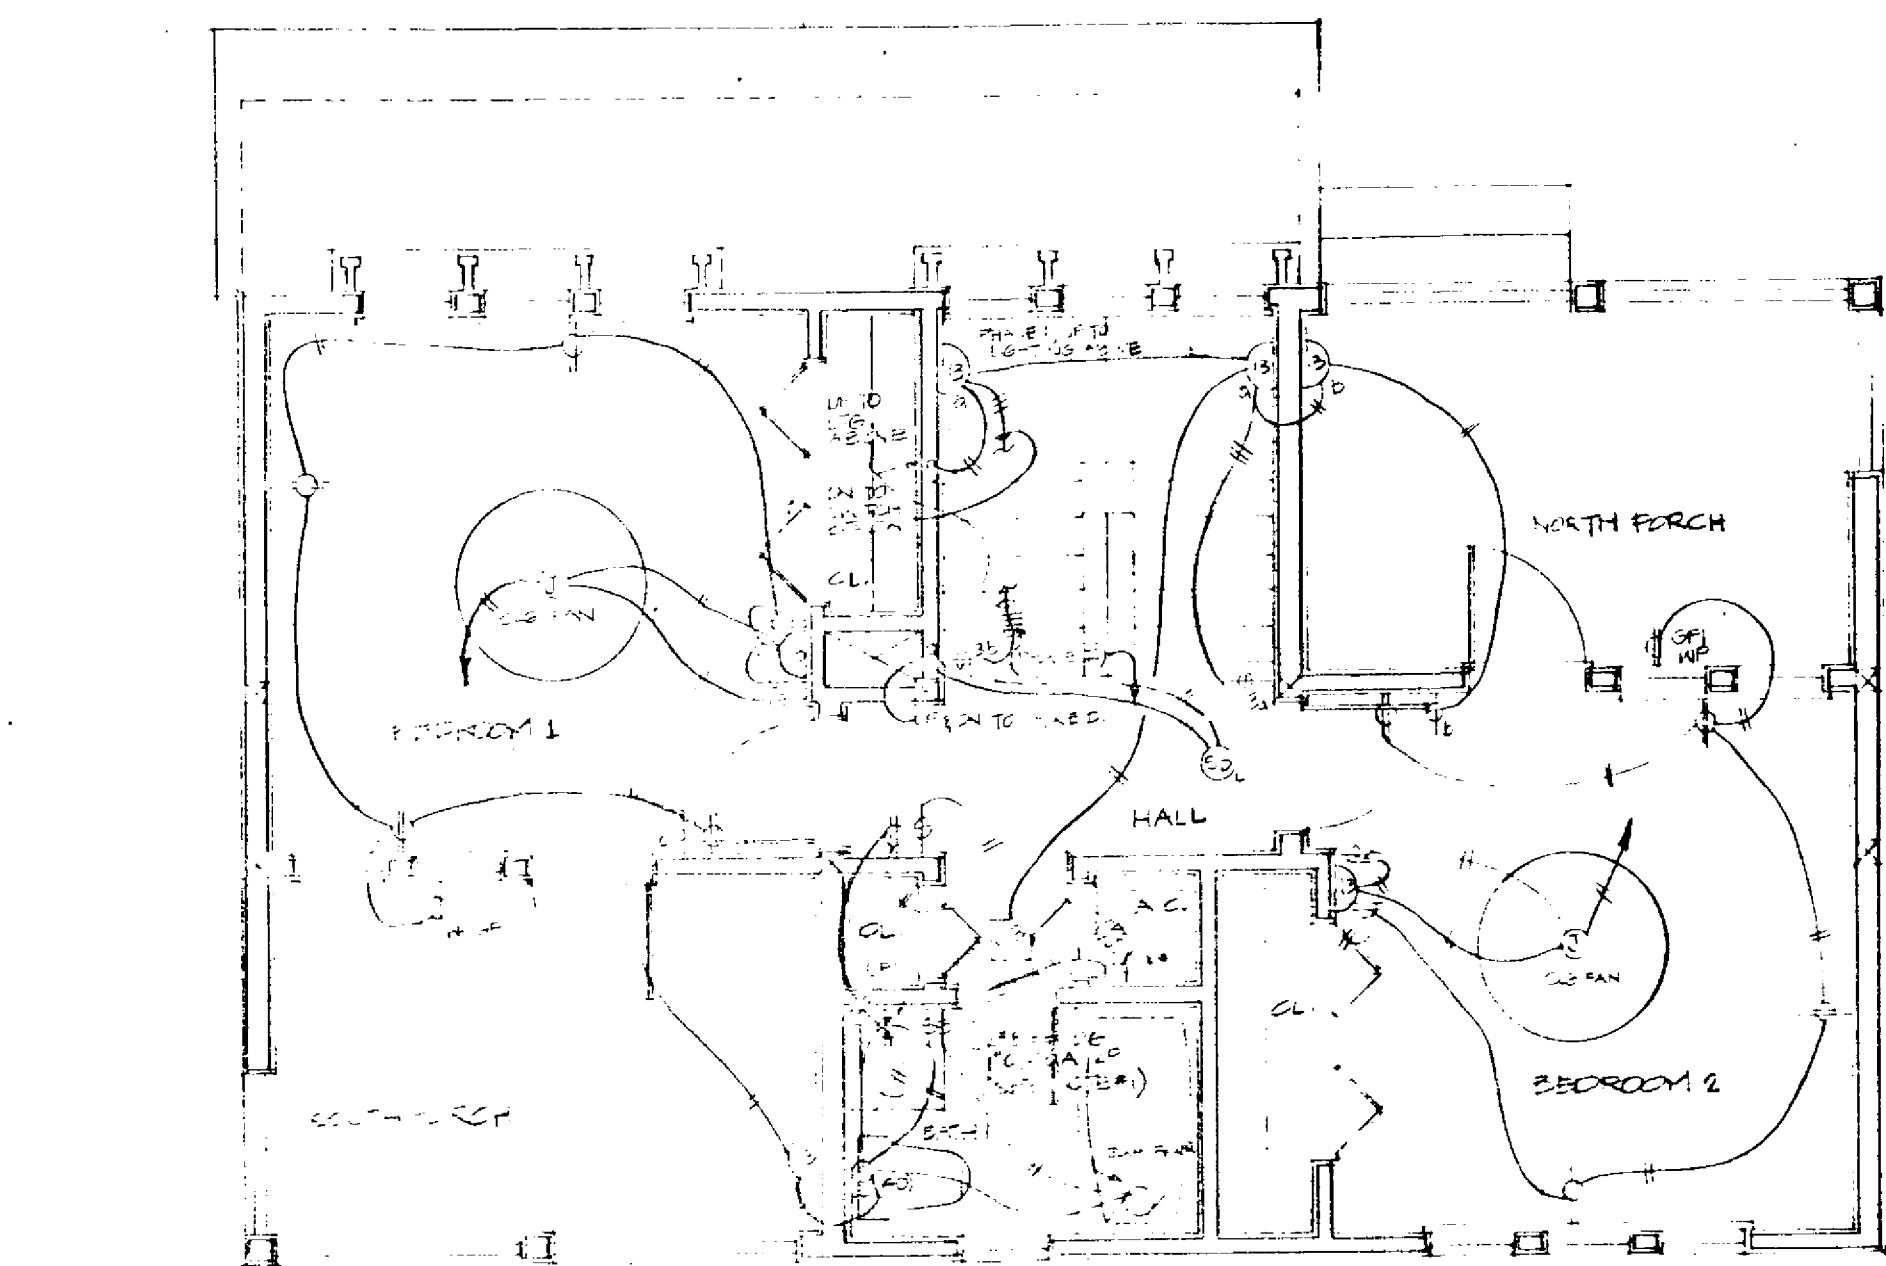- Replace 60A 2P disconnect with a Thermal Element Switch 'T', replace 50A 2P C/B and branch circuit wiring with a 20A 1P C/B and 2*12 & *12G in 1/2" C, if a gas air conditioner/heater is to be utilized.
- Replace 30A 2P C/B and branch circuit wiring with a 20A 1P C/B and 2*12 & *12G in 1/2" C, replace 30A 250V special purpose receptacle with a duplex grounding type receptacle, if a gas dryer is to be utilized.
- Replace 60A 2P C/B and branch circuit wiring with a 20A 1P C/B and 2*12 & *12G in 1/2" C, replace 60A 2P 120/250V special purpose receptacle with a duplex grounding type receptacle, if a gas range is to be utilized.
- Replace 30A 2P disconnect with a junction box, replace 30A 2P C/B and a branch circuit wiring with a 20A 1P C/B and 2*12 & *12G in 1/2" C, if a gas water heater is to be utilized.



PHASE I: MASTER BEDROOM SUITE
THIRD FLOOR ELEC PLAN

SYMBOL LIST

Number in () refers to maximum voltage

- (1) Fluorescent fixture, wall mt'd; 6'-6" AFF or at underside of cab.
- (2) Fluorescent fixture, ceiling surface mounted
- (3) Compact fluorescent wall sconce; 6'-0" AFF
- (4) Ceiling fan
- (5) Ceiling fan (pull chain), with switched light fixture.
- (6) Exhaust fan, flush ceiling mt'd.
- Switches:** 15 amp, 120V/120V - 1-0 & AFF except as noted
 - (1a) Single pole
 - (1b) Three way
 - (1c) Single pole switch with thermal element
 - (1d) Dimmer switch
- Receptacles:** 15 A 125V grounding type MH 1-6 & AFF except as noted.
 - (2a) Duplex, wall mounted
 - (2b) Duplex, ground fault interrupter type
 - (2c) Duplex, weatherproof
 - (2d) Duplex, mounted 3'-6" AFF (above or through back splash)
 - (2e) Special purpose, refer to equipment mfr. for type:
Orange - 60A 125/250V grounding type; dryer - 30A 125/250V grounding type.
 - (2f) Duplex with top outlet switched.

Motor controls and Distribution Equipment


- (3) 30A Non-fuseable disconnect switch, rating as indicated.
- (4) 20A Fusible disconnect switch, rating as indicated.
- (5) Motor, numeral indicates horsepower.
- (6) Load center, 5'-0" to top.
- (7) Junction box, wall or ceiling flush mounted with blank cover plate and anchored as necessary for future fan or fixture.

Conduit and wiring branch and feeder

- (8) Conduit and wiring, diagonal lines indicate number of wires, grounding wire not shown.
- (9) Homerrun to load center, 2*12 and *12G, 1/2" C to 20A-1P Circuit breaker, typical except as noted.
- (10) Flexible conduit and equipment connection.


Miscellaneous

- (11) Smoke detector, 120V local type, with integral audible device.

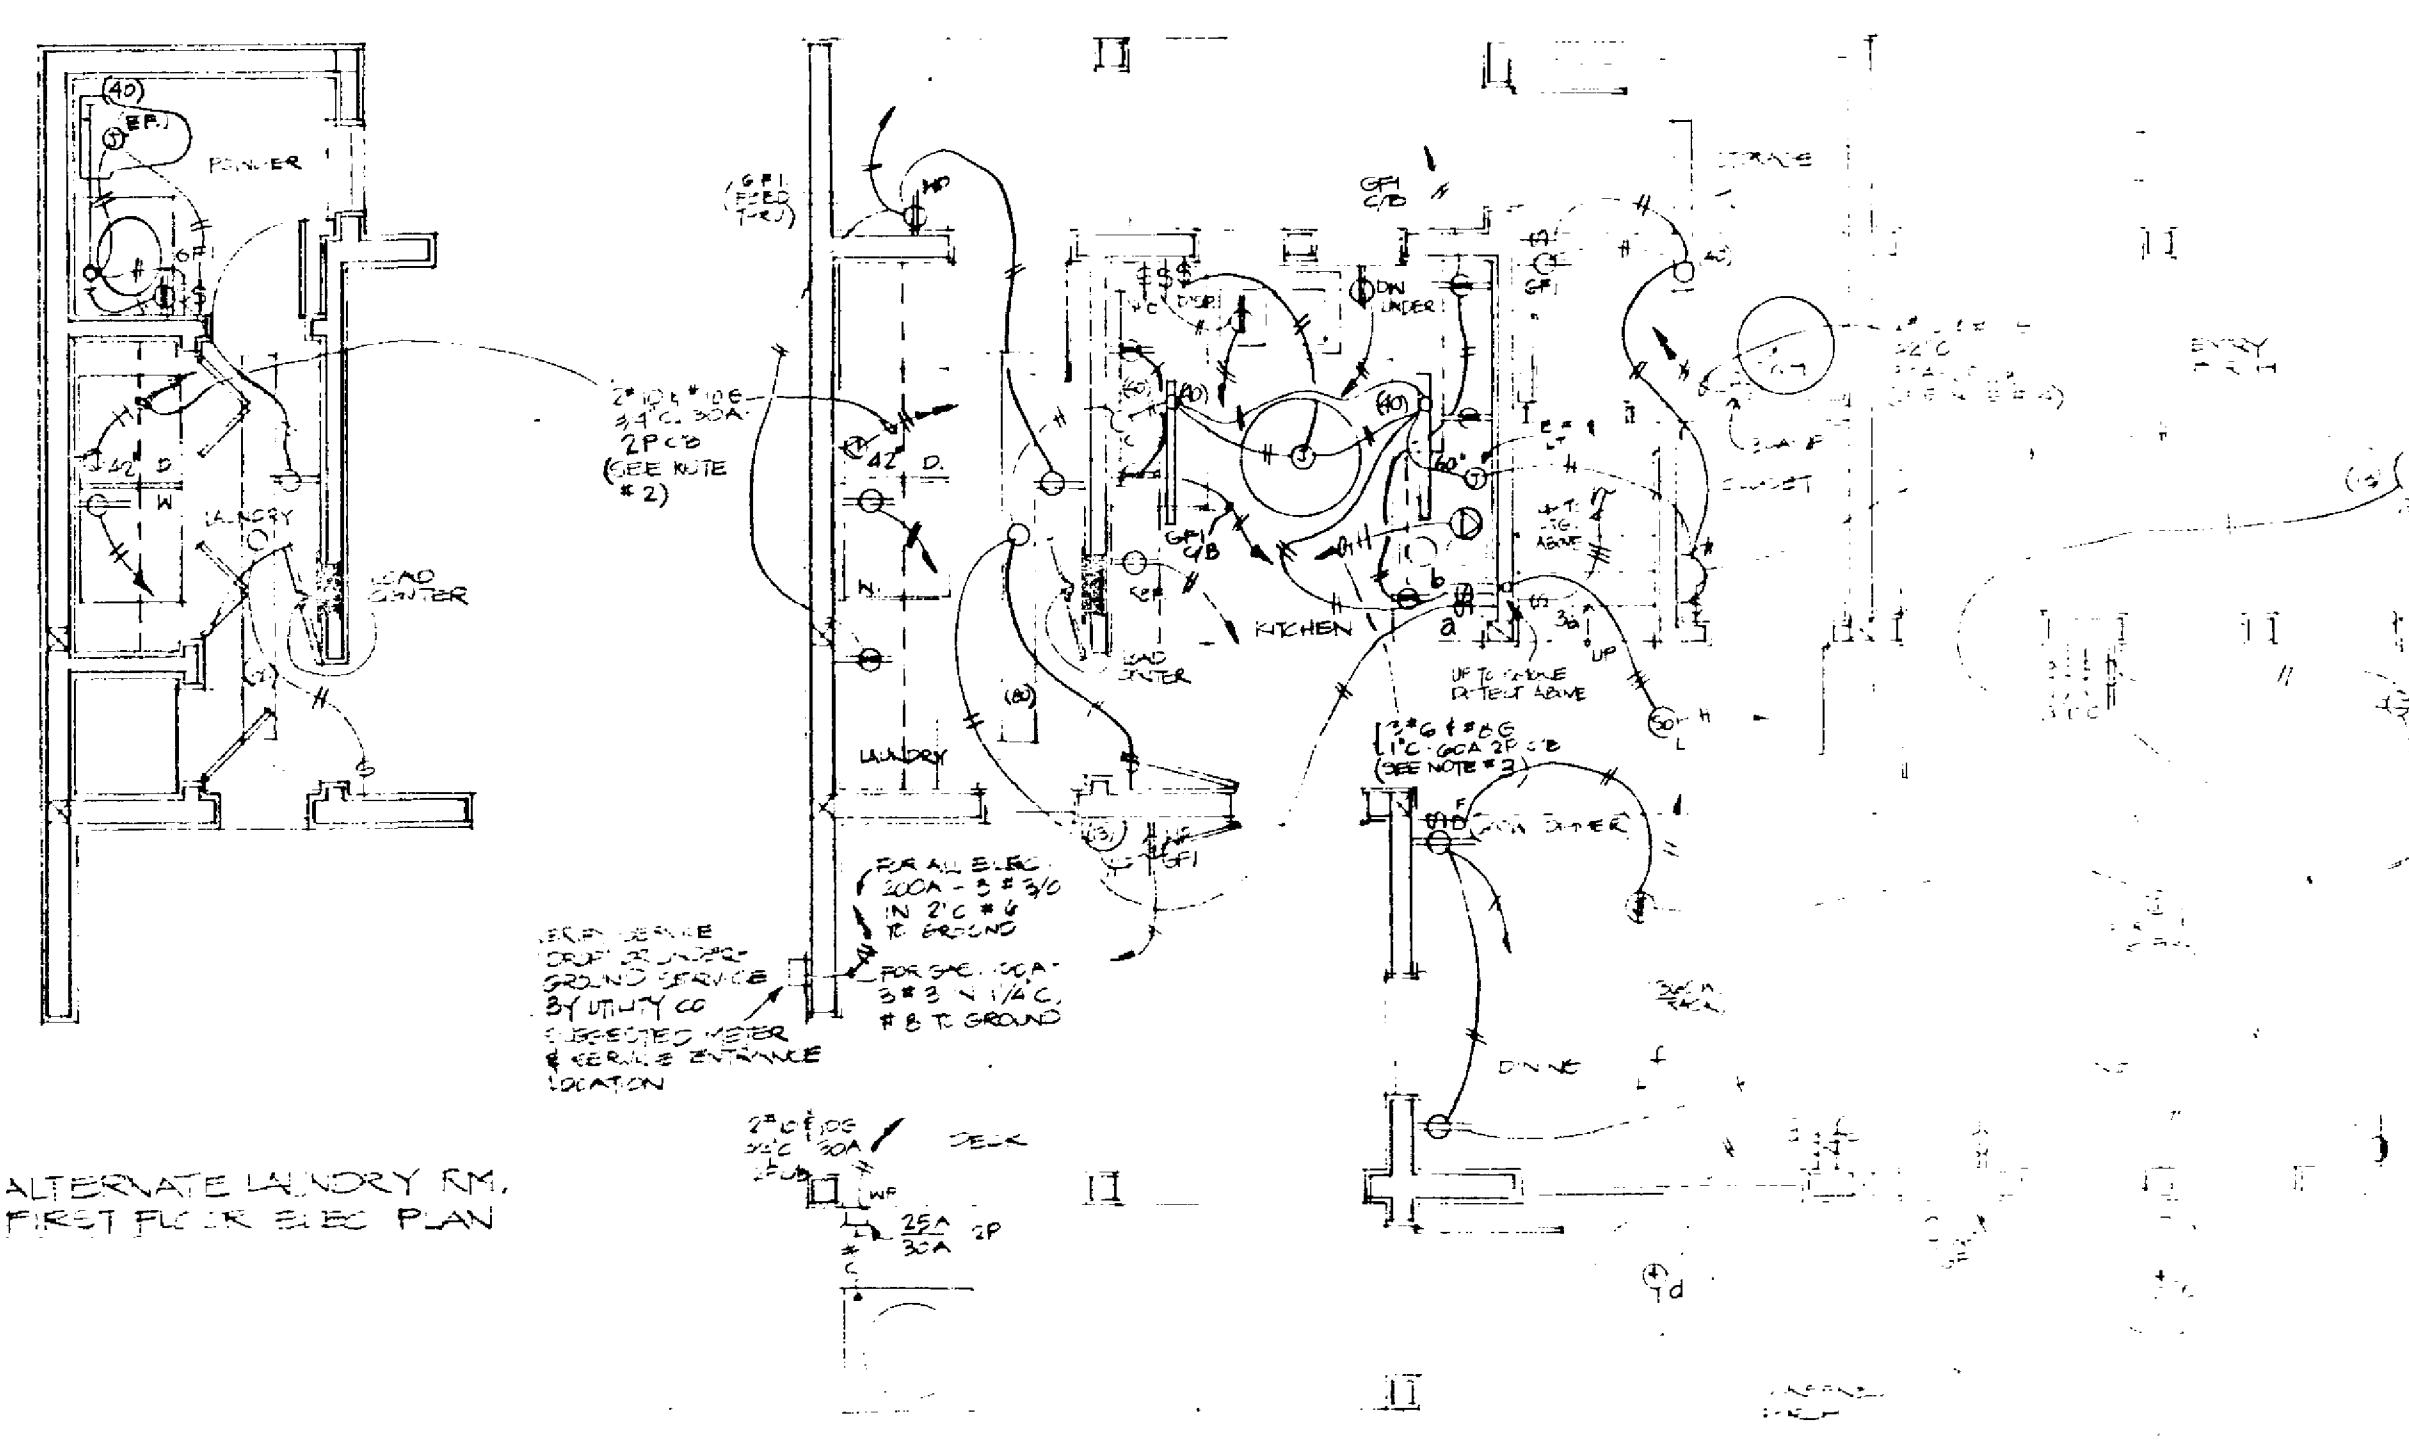

FIRST FLOOR ELEC PLAN

- Dwelling unit receptacles and lighting circuits may be fed from 15A 1P circuit breakers using #14 AWG copper wire. Small appliance circuits or dedicated circuits shall be fed from 20A 1P circuit breakers using #12 AWG copper wire (typical).
- All electrical conduit and raceways shall be run concealed. Conduit and circuitry indicated on the drawings are diagrammatic only (unless noted otherwise). Final location of conduit shall be field coordinated so as to avoid conflicts with other trades.
- Wire and conduit sizes indicated on homeruns shall run continuous throughout circuit.
- Telephone and television prewiring are not shown and the locations are to be coordinated with the owner.
- All electrical work shall meet or exceed the latest requirements of all national, state, municipal and other authorities having jurisdiction over electrical construction work and the project.

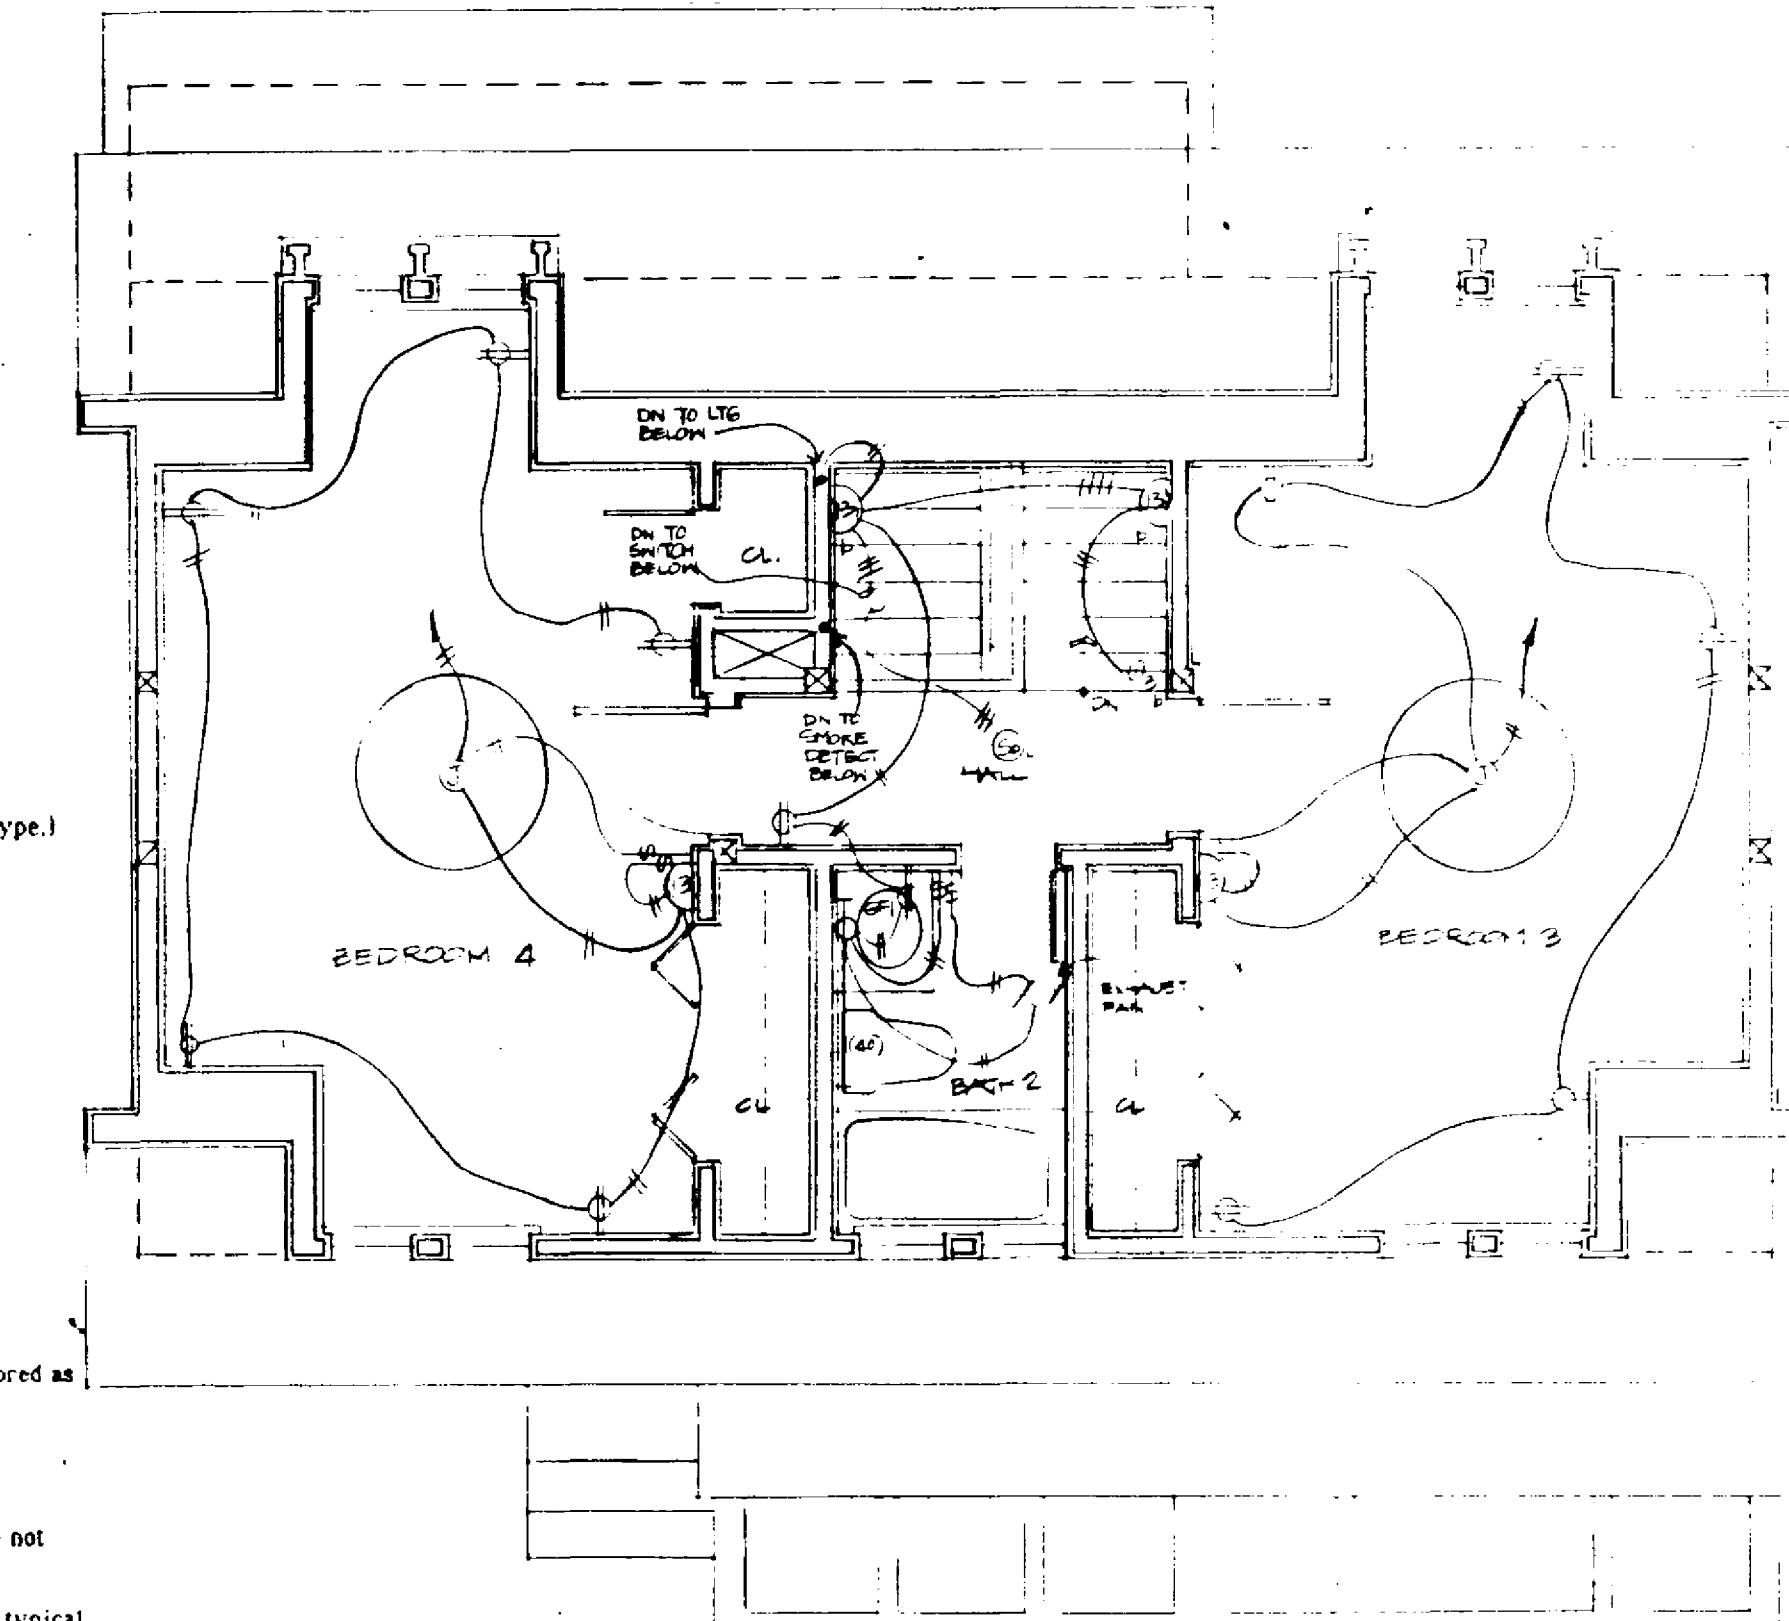

ALTERNATE
THIRD FLOOR ELEC. PLAN

LOAD CENTER w/ elec. appliances	
1/2 phase	
Circuit Amp	Pole Load
1. 60	2 *** 6.0/
3. 20	1 - 6.0
5. 20	2 5600 2.5/
7. -	- 7.2
9. 30	2 5500 2.7/
11. -	- 7.2
13. 20	1 1500 1.5/
15. 20	1 700 .70
17. 20	1 1200 1.2/
19. 20	1 500 .70
21. 20	1 1100 1.1/
23. 20	1 1000 1.1/
25. 20	1 1500 1.5/
27. 20	1 - spare
29. 20	1 - spare
31. 20	1 - spare
1/3 phase	
Circuit Amp	Pole Load
2. 50	4 5400
4. -	4.2
6. 20	2 3100
8. -	- 2.6
10. 20	1 1500 1.5/
12. 20	1 1500 1.5/
14. 20	1 1500 1.5/
16. 20	1 1000 1.0/
18. 20	1 1300 1.3/
20. 20	1 1300 1.3/
22. 20	1 1300 1.3/
24. 20	1 1200 1.2/
26. -	- spare
28. 20	1 - spare
30. 20	1 - spare

LOAD SUMMARY

Electrical Appliances

1. General lighting	14,200 (VA)
Small appliance	4,500 (VA)
Total	18,700 (VA)

First 3000 (VA) + 100% - 3,000 (VA)
Remaining 15,700 (VA) + 35% - 5,300 (VA)
Total 8,500 (VA)

2. Range	12,000 (VA) part 220-19 NEC	8,000 (VA)
3. Water heater	5,500 (VA) 100%	5,500 (VA)
4. Heating	11001	8,400 (VA)
5. A/C (smaller than heating)	- 0	- 0
6. Clothes Dryer	110051	5,000 (VA)
Total	35,400 (VA)	

+ 3,400 (VA) + 240 V - 14.7 amps. 120/240 V 1P 3W service
with 200A load center

LOAD CENTER w/ gas appliances	
1/2 phase	
Circuit Amp	Pole Load
1. 20	1 200 0.2/
3. 20	1 700 .70
5. 20	1 200 0.2/
7. 20	1 1500 1.5/
9. 20	1 700 0.2/
11. 20	1 1200 1.2/
13. 20	1 500 0.5/
15. 20	1 1000 1.1/
17. 20	1 1000 1.0/
19. 20	1 1500 1.5/
21. 20	1 - spare
23. 20	1 - spare
25. 20	1 - spare
27. 20	1 - spare
29. 20	1 - spare
1/3 phase	
Circuit Amp	Pole Load
2. 30	2 3100 1/6
4. -	- 1.6
6. 20	1 1000 1/6
8. 20	1 1500 1/6
10. 20	1 1500 1/6
12. 20	1 1500 1/6
14. 20	1 1500 1/6
16. 20	1 1000 1/6
18. 20	1 1300 1/6
20. 20	1 1300 1/6
22. 20	1 1300 1/6
24. 20	1 1200 1/6
26. -	- spare
28. 20	1 - spare
30. 20	1 - spare

Gas Appliances

1. General lighting	15,300 (VA)
Small appliance	4,500 (VA)
Total	19,800 (VA)
First 3000 (VA) + 100% - 3,000 (VA)	- 3,000 (VA)
Remaining 16,800 (VA) + 35% - 5,900 (VA)	- 5,900 (VA)

2. Range	(gas)	- 0
3. Water heater	(gas)	- 0
4. Heating	(gas)	- 0
5. A/C	(gas)	4,100 (VA)
6. Clothes Dryer	(gas)	- 0
Total	13,000 (VA)	

13,000 (VA) + 250 V - 54.2 amps. 120/240 V 1P 3W service
with 100A load center

Drawing Title:

ELECTRICAL PLANS

Drawing Number:

E-1